Parish Hall Package B VICTORIA, TEXAS

ADDENDUM 2 29 APRIL 2016 0114-716B

Parish Hall Package B Our Lady of Victory - Diocese of Victoria Project # 716-0114 B

Rawley McCoy & Associates 1908 N. Laurent St. Suite 540 Victoria, TX 77901 361-573-1642 Fax 361-573-2114



ADDENDUM NUMBER TWO

April 29, 2016

Acknowledge receipt of this addendum in the appropriate space provided on the proposal form. Failure to do so may subject bidder to disqualification. This addendum shall become part of the bidding documents and shall modify them as enumerated below.

REQUEST FOR INFROMATION (RFI)

- 1. RFI 3, see attached
- 2. RFI 5, see attached
- 3. RFI 6, see attached

SPECIFICATIONS

 SECTION 04 20 00 – UNIT MASONRY, MASONRY CLEANERS & SEALERS, B. BRICK SEALER, 1

Revision: CHANGE "1. Sonneborn White Roc 10 Plus water-repellent."

> TO "1. Sherwin Williams: Loxon 7% Siloxane Water Repellant A10T00007"

2. SECTION 08 80 00 - GLAZING, GLASS & GLAZING TYPES, C

Revision: CHANGE "C. Interior glass shall be 1/4" thick laminated

Safety glass, clear, with .030 plastic interlayer."

TO "C. Interior glass shall be 1/4" thick tempered

Safety glass, clear."

DRAWINGS

1. BA1.1R1 FLOOR PLAN - LEVEL 1 NORTH

Revision: SEE ATTACHED

Revised wall furring

Added casework in Meeting 102

2. BA1.2R1 COUNSELING CENTER FLOOR PLAN

Revision: SEE ATTACHED

Revised wall location

Enlarged rooms 133, 134 and 135

3. BA2.1R1 COUNSELING CENTER ENLARGED FLOOR PLAN

Revision: **SEE ATTACHED**

Revised wall location

Enlarged rooms 133, 134 and 135

4. BA3.1R1 COUNSELING CENTER REFLECTED CEILING PLAN

Revision: **SEE ATTACHED**

Revised wall location

Enlarged rooms 133, 134 and 135 Room 113 and 114 ceiling heights

5. BA8.1R1 FINISH PLAN & MATERIAL SCHEDULE

Revision: REPLACE BA8.1 FINISH PLAN & MATERIAL

SCHEDULE

WITH BA8.1R1 FINISH PLAN & MATERIAL

SCHEDULE

Miscellaneous corrections to room finishes

No flooring in Parish Hall 110 Counseling Center layout changes

6. MECHANICAL SHEETS - Revised Mechanical Systems

Revision:	REPLACE	BM2.1	HVAC FLOOR PLAN – LEVEL 1
	WITH	BM2.1R1	HVAC FLOOR PLAN – LEVEL 1

REPLACE BM2.2 HVAC FLOOR PLAN – LEVEL 1
WITH BM2.2R1 HVAC FLOOR PLAN – LEVEL 1

REPLACE BM2.3 HVAC FLOOR PLAN – LEVEL 2 WITH BM2.3R1 HVAC FLOOR PLAN – LEVEL 2

REPLACE BM2.4 HVAC ROOF PLAN WITH BM2.4R1 HVAC ROOF PLAN

REPLACE	BM2.5	1/4" SCALE MECH. ROOMS, SYMBOLS, ABBRV. & GENERAL NOTES
WITH	BM2.5R1	1/4" SCALE MECH. ROOMS, SYMBOLS, ABBRV. & GENERAL NOTES
REPLACE WITH	BM3.1 BM3.1R2	HVAC SCHEDULES HVAC SCHEDULES

Attachments:

1.	RFI3		1 page
2.	RFI 5		1 page
3.	RFI 6		2 page
4.	BA1.1R1	FLOOR PLAN – LEVEL 1 NORTH	1 page
5.	BA1.2R1	COUNSELING CENTER FLOOR PLAN	1 page
6.	BA2.1R1	COUNSELING CENTER ENLARGED FLOOR PLAN	1 page
7.	BA3.1R1	COUNSELING CENTER REFLECTED CEILING PLAN	1 page
8.	BA8.1R1	FINISH PLAN & MATERIAL SCHEDULE	1 page
9.	BM2.1R1	HVAC FLOOR PLAN – LEVEL 1	1 page
10.	BM2.2R1	HVAC FLOOR PLAN – LEVEL 1	1 page
11.	BM2.3R1	HVAC FLOOR PLAN – LEVEL 2	1 page
12.	BM2.4R1	HVAC ROOF PLAN	1 page
13.	BM2.5R1	1/4" SCALE MECH. ROOMS, SYMBOLS, ABBRV. & GEN	IERAL
	NOTES		1 page
14.	BM3.1R2	HVAC SCHEDULES	1 page

End of Addendum

RFI 3

1. Toilet 133 – do all walls receive ceramic tile? Is the tile full height?

RMA: Yes, all walls receive tile. Tile to extend 4'-0" A.F.F., use Schulter Rondec-db at perimeter (horz. & vert.) and outside corners

2. Unisex 108 - do all walls receive ceramic tile? Is the tile full height?

RMA: Yes, all walls receive tile. Tile to extend 4'-0" A.F.F., use Schulter Rondec-db at perimeter (horz. & vert.) and outside corners

3. Kitchen 114 – is the FRP full wall height?

RMA: FRP1 to extend from tile base to ceiling. Ceiling height to be addressed in a future Addendum

4. Kitchen 114 has a closet. Is the finish of the walls in this closet FRP? What is the height?

RMA: Closet 116 to receive FRP1 from base to ceiling. Ceiling height to be addressed in a future Addendum

5. On the Finish Plan and Material Schedule – what is PNT? Several rooms have this notation. Reference Specification Sections 087100 and 084000

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RMA: P1 - 105, 112, 115, 139, 125, 132, 136,
P1/P3 - 137, 138
P3 - 113
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- Can Falcon brand hardware be used for the exit devices related to the Storefront Doors?RMA: Yes
- 7. To be sure that Hardware Set No. 1 is bid by a vendor, please move that hardware set from Section 087100 to Section 084000 and note that the storefront subcontractor is responsible for providing and installing this hardware set.

RMA: The storefront contractor can provide the hardware for the storefront doors. This will be addressed in a future Addendum.



OWNER	[]
Architect / Designer	[X]
Contractor	[]
Engineer	[]
FIELD	[]
OTHER	[]

REQUEST FOR INFORMATION

PROJECT:	RFI No: <u>005</u>
Our Lady of Victory-Parish Hall	Date of Issuance: 4-27-16
OWNER: Our Lady of Victory	Architect/Designer: Rawley McCoy & Associates
To: Patrick Ohrt	PROJECT No: 716-0114B
and/or necessitated by said response. An adequate response designated party above to whom this communication was	s for information in the form of an ASI, Proposal Request, and/or a qualified transmittal as dictated se is requested within <u>one</u> (1) day/s after the receipt of the Request for Information by the submitted or must notify the Contractor of the anticipated date on which a submission is anticipated. It party to which the Request for Information is submitted, said party should contact the requestor due delay of further delay to construction.
ITEM/s: 1. Plumbing - Please define what L. 2. Plumbing - Please define what D. 3. Tile-We have been informed that Please advise. ATTACHMENTS:	
ISSUED BY: LAV-3 shall be same as LAV-2 e Sharon Rose Fisher - Estimator Lauger Companies Incl be a Sioux Chief 696-	xcept faucet shall be Moen 8430 Single Handle manual faucet. 6 Ox Box drain box or similar.
RESPONSE:	Attachments:
	aucet shall be Moen 8430 Single Handle manual faucet.
Issued By:	
Authorized Signature	
PATRICK OHRT	
Printed Name / Title	
04.29.16	
Date Issued	
	Evro or Doory mys

END OF DOCUMENT



OWNER	[]
Architect / Designer	[X]
CONTRACTOR	[]
Engineer	[]
FIELD	[]
OTHER	[]

REQUEST FOR INFORMATION

PROJECT:	RFI NO: <u>006</u>					
Our Lady of Victory-Parish Hall	Date of Issuance: 4-28-16					
OWNER: Our Lady of Victory	Architect/Designer: Rawley McCoy & Associates					
To: Patrick Ohrt	PROJECT No: 716-0114B					
and/or necessitated by said response. An adequate response is requered signated party above to whom this communication was submitted	mation in the form of an ASI, Proposal Request, and/or a qualified transmittal as dictated sted within <u>one</u> (1) day/s after the receipt of the Request for Information by the or must notify the Contractor of the anticipated date on which a submission is anticipated, which the Request for Information is submitted, said party should contact the requestor of further delay to construction.					
2. Casework-Do any cabinets in rooms 113	estrooms 106 and 107 to be made of? Plam, solid surface, etc.? and 114 require locks? If so, please define locations. iied to the structure above, on two corners of the light fixtures? The is to take place.					
Issued By:						
Sharon Rose Fisher -Estimator Lauger Companies, Inc.						
RESPONSE:	ATTACHMENTS:					
Issued By:						
Authorized Signature						
PATRICK OHRT						
Printed Name / Title						
04.29.16						
Date Issued						
· · · · · · · · · · · · · · · · · · ·	-					

END OF DOCUMENT

RFI 6


1. Casework-What are the countertops in Restrooms 106 and 107 to be made of? Plam, solid surface, etc.?


RMA: Refer to H1/BA9.1 for Restroom 106 and 107 counter tops. Counter tops to be 2-layers 3/4" plywood with PL2 plastic laminate finish.


2. Casework-Do any cabinets in rooms 113 and 114 require locks? If so, please define locations.

RMA: No locks are required.

3. Electrical-is it acceptable to use tie wire, tied to the structure above, on two corners of the light fixtures? The specifications do not clearly define what is to take place. RMA: Please refer to BE2.2 Lighting Fixture Schedule for the following: Delete the Remarks for lighting fixture type "K" and insert the following in lieu thereof: "SUSPEND WITH BOTTOM OF FIXTURE LEVEL WITH BOTTOM OF CEILING. SUSPEND FIXTURE FROM ROOF STRUCTURE. PROVIDE CHANNEL STRUT ATTACHED TO BOTTOM OF STRUCTURE FOR SUSPENSION. FIXTURE SHALL BE SUSPENDED IN OPENING WHERE CEILING TILE IS NOT INSTALLED. PROVIDE WITH AIR CRAFT CABLE V-HANGERS, SO CORD, WIREGUARD, AND nLIGHT ENABLED."

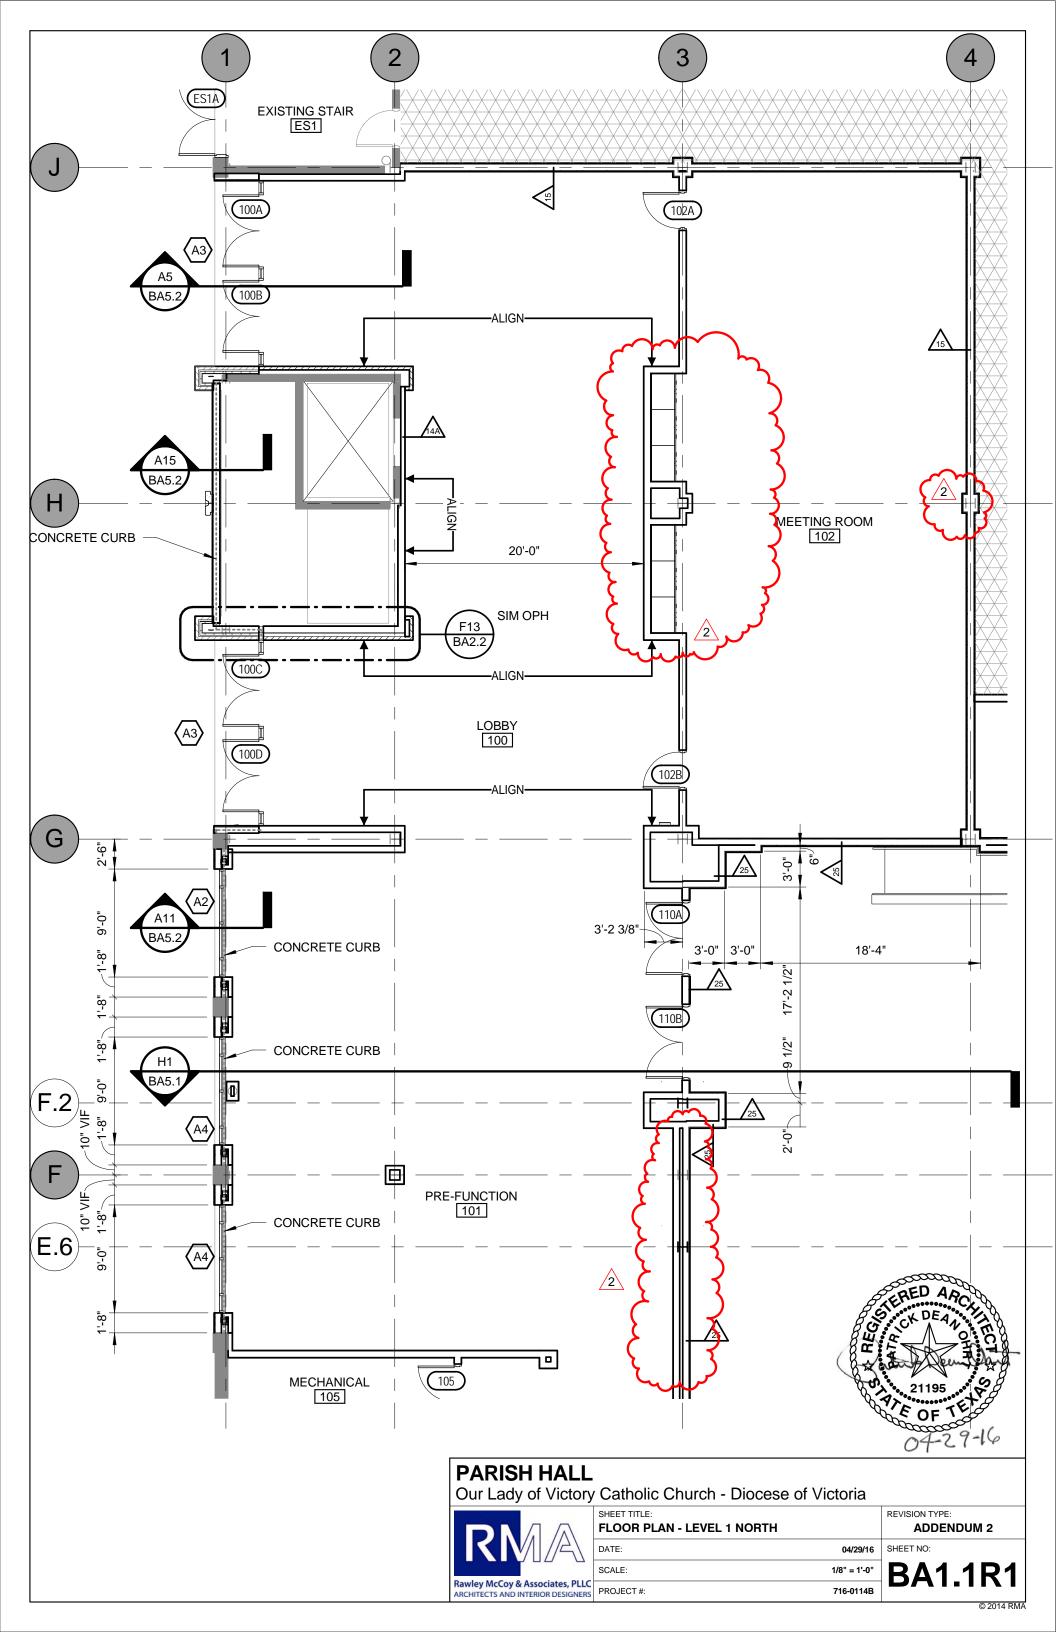

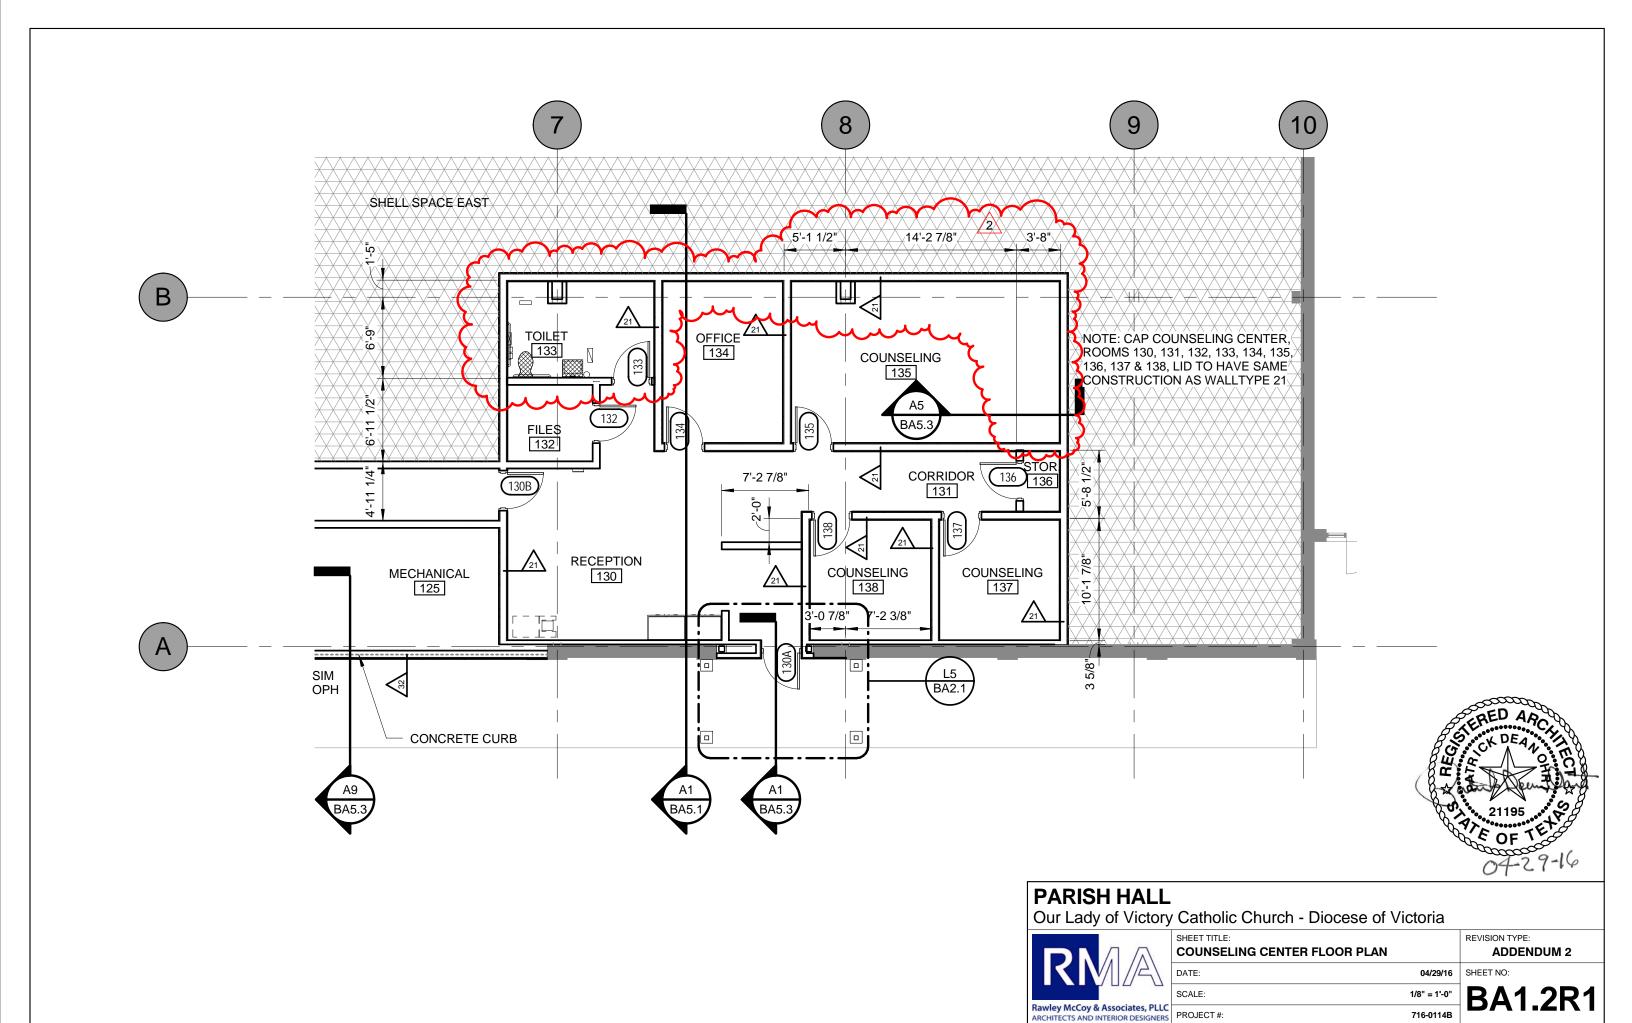

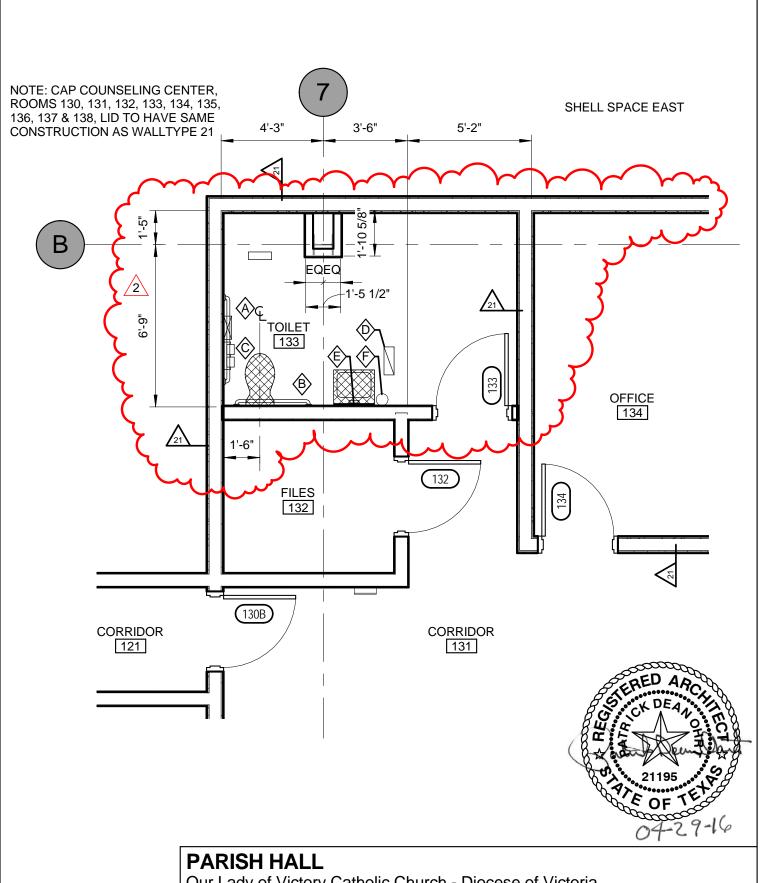


Our Lady of Victory Catholic Church - Diocese of Victoria




SHEET TITLE:
COUNSELING CENTER ENLARGED PLAN
DATE.

04/29/16 SCALE: 1/4" = 1'-0" PROJECT #: 716-0114B

REVISION TYPE: **ADDENDUM 2**

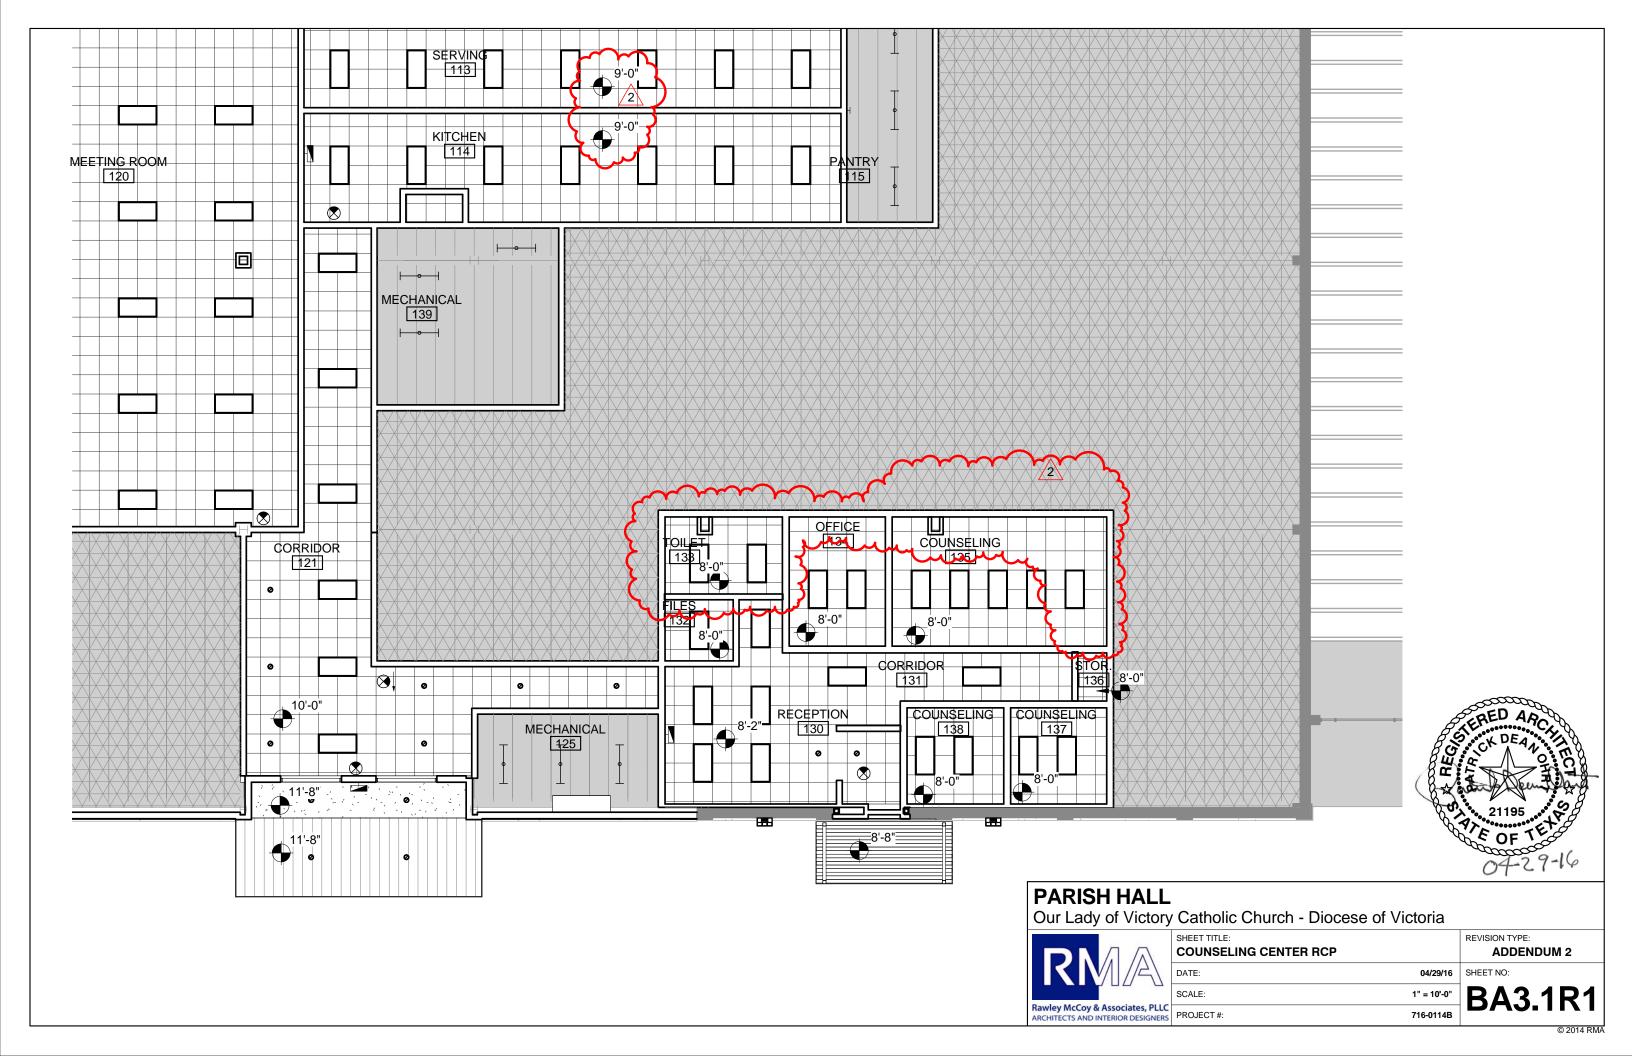

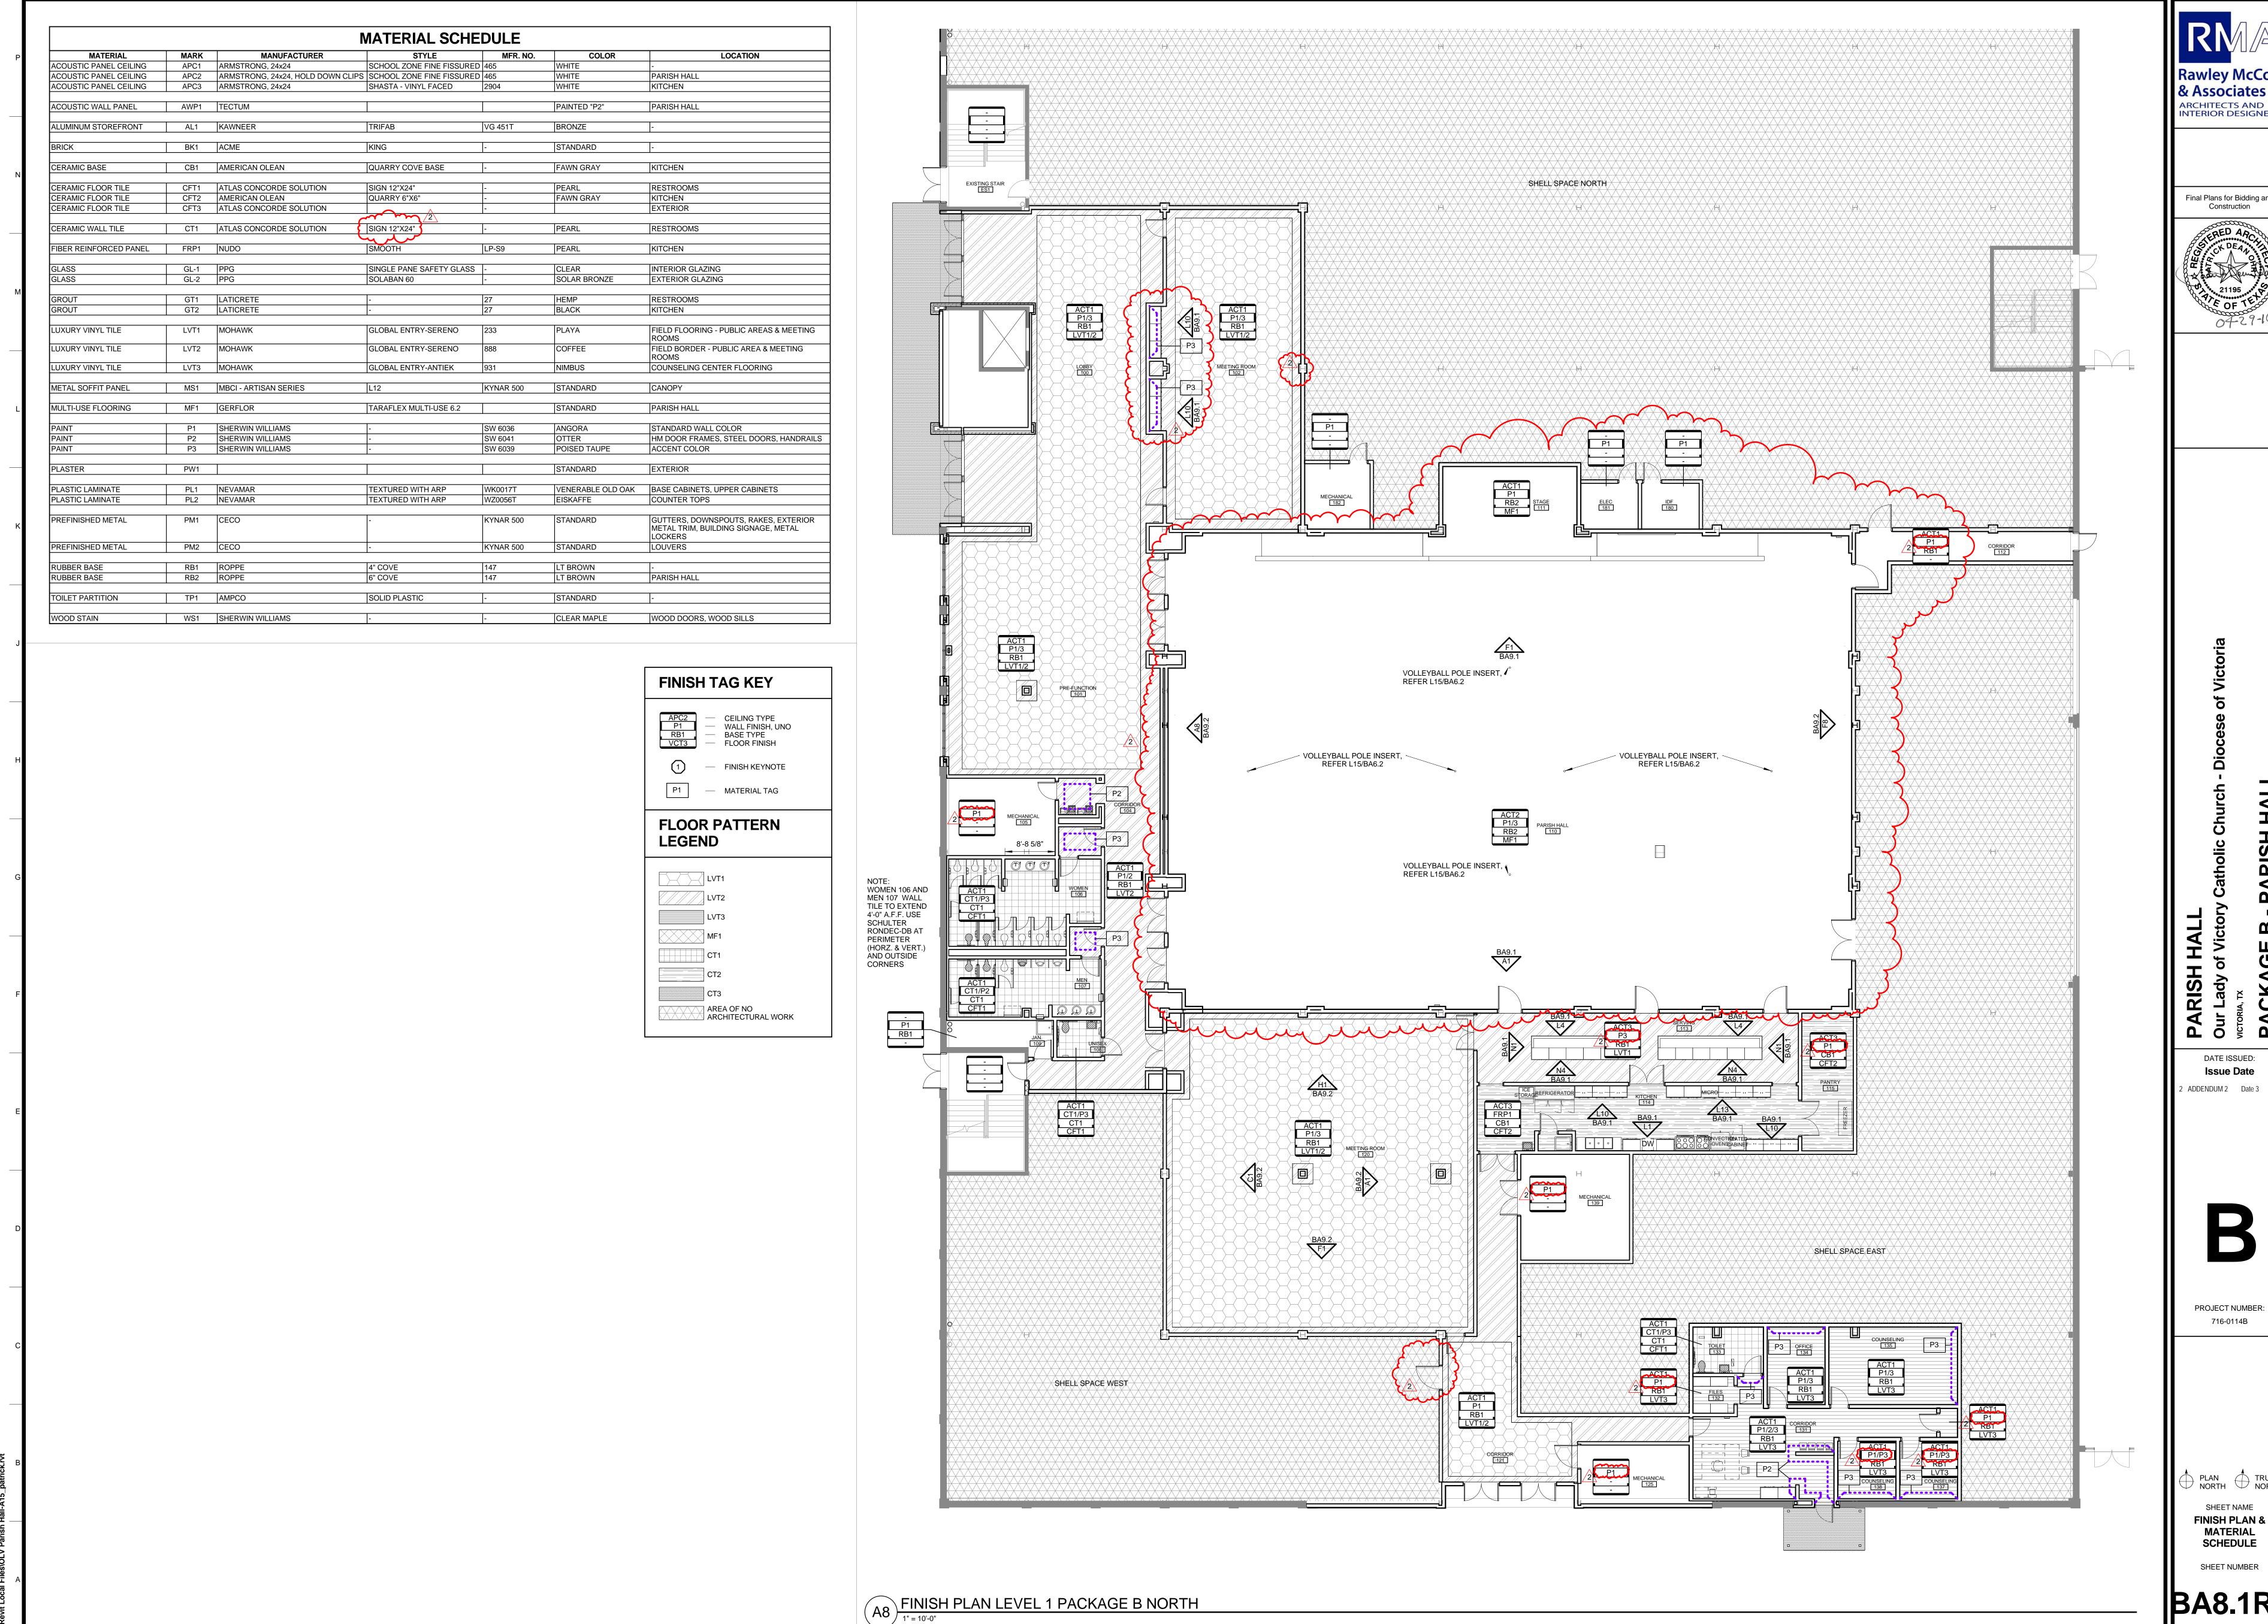



& Associates ARCHITECTS AND INTERIOR DESIGNERS

Final Plans for Bidding and




✓ NORTH

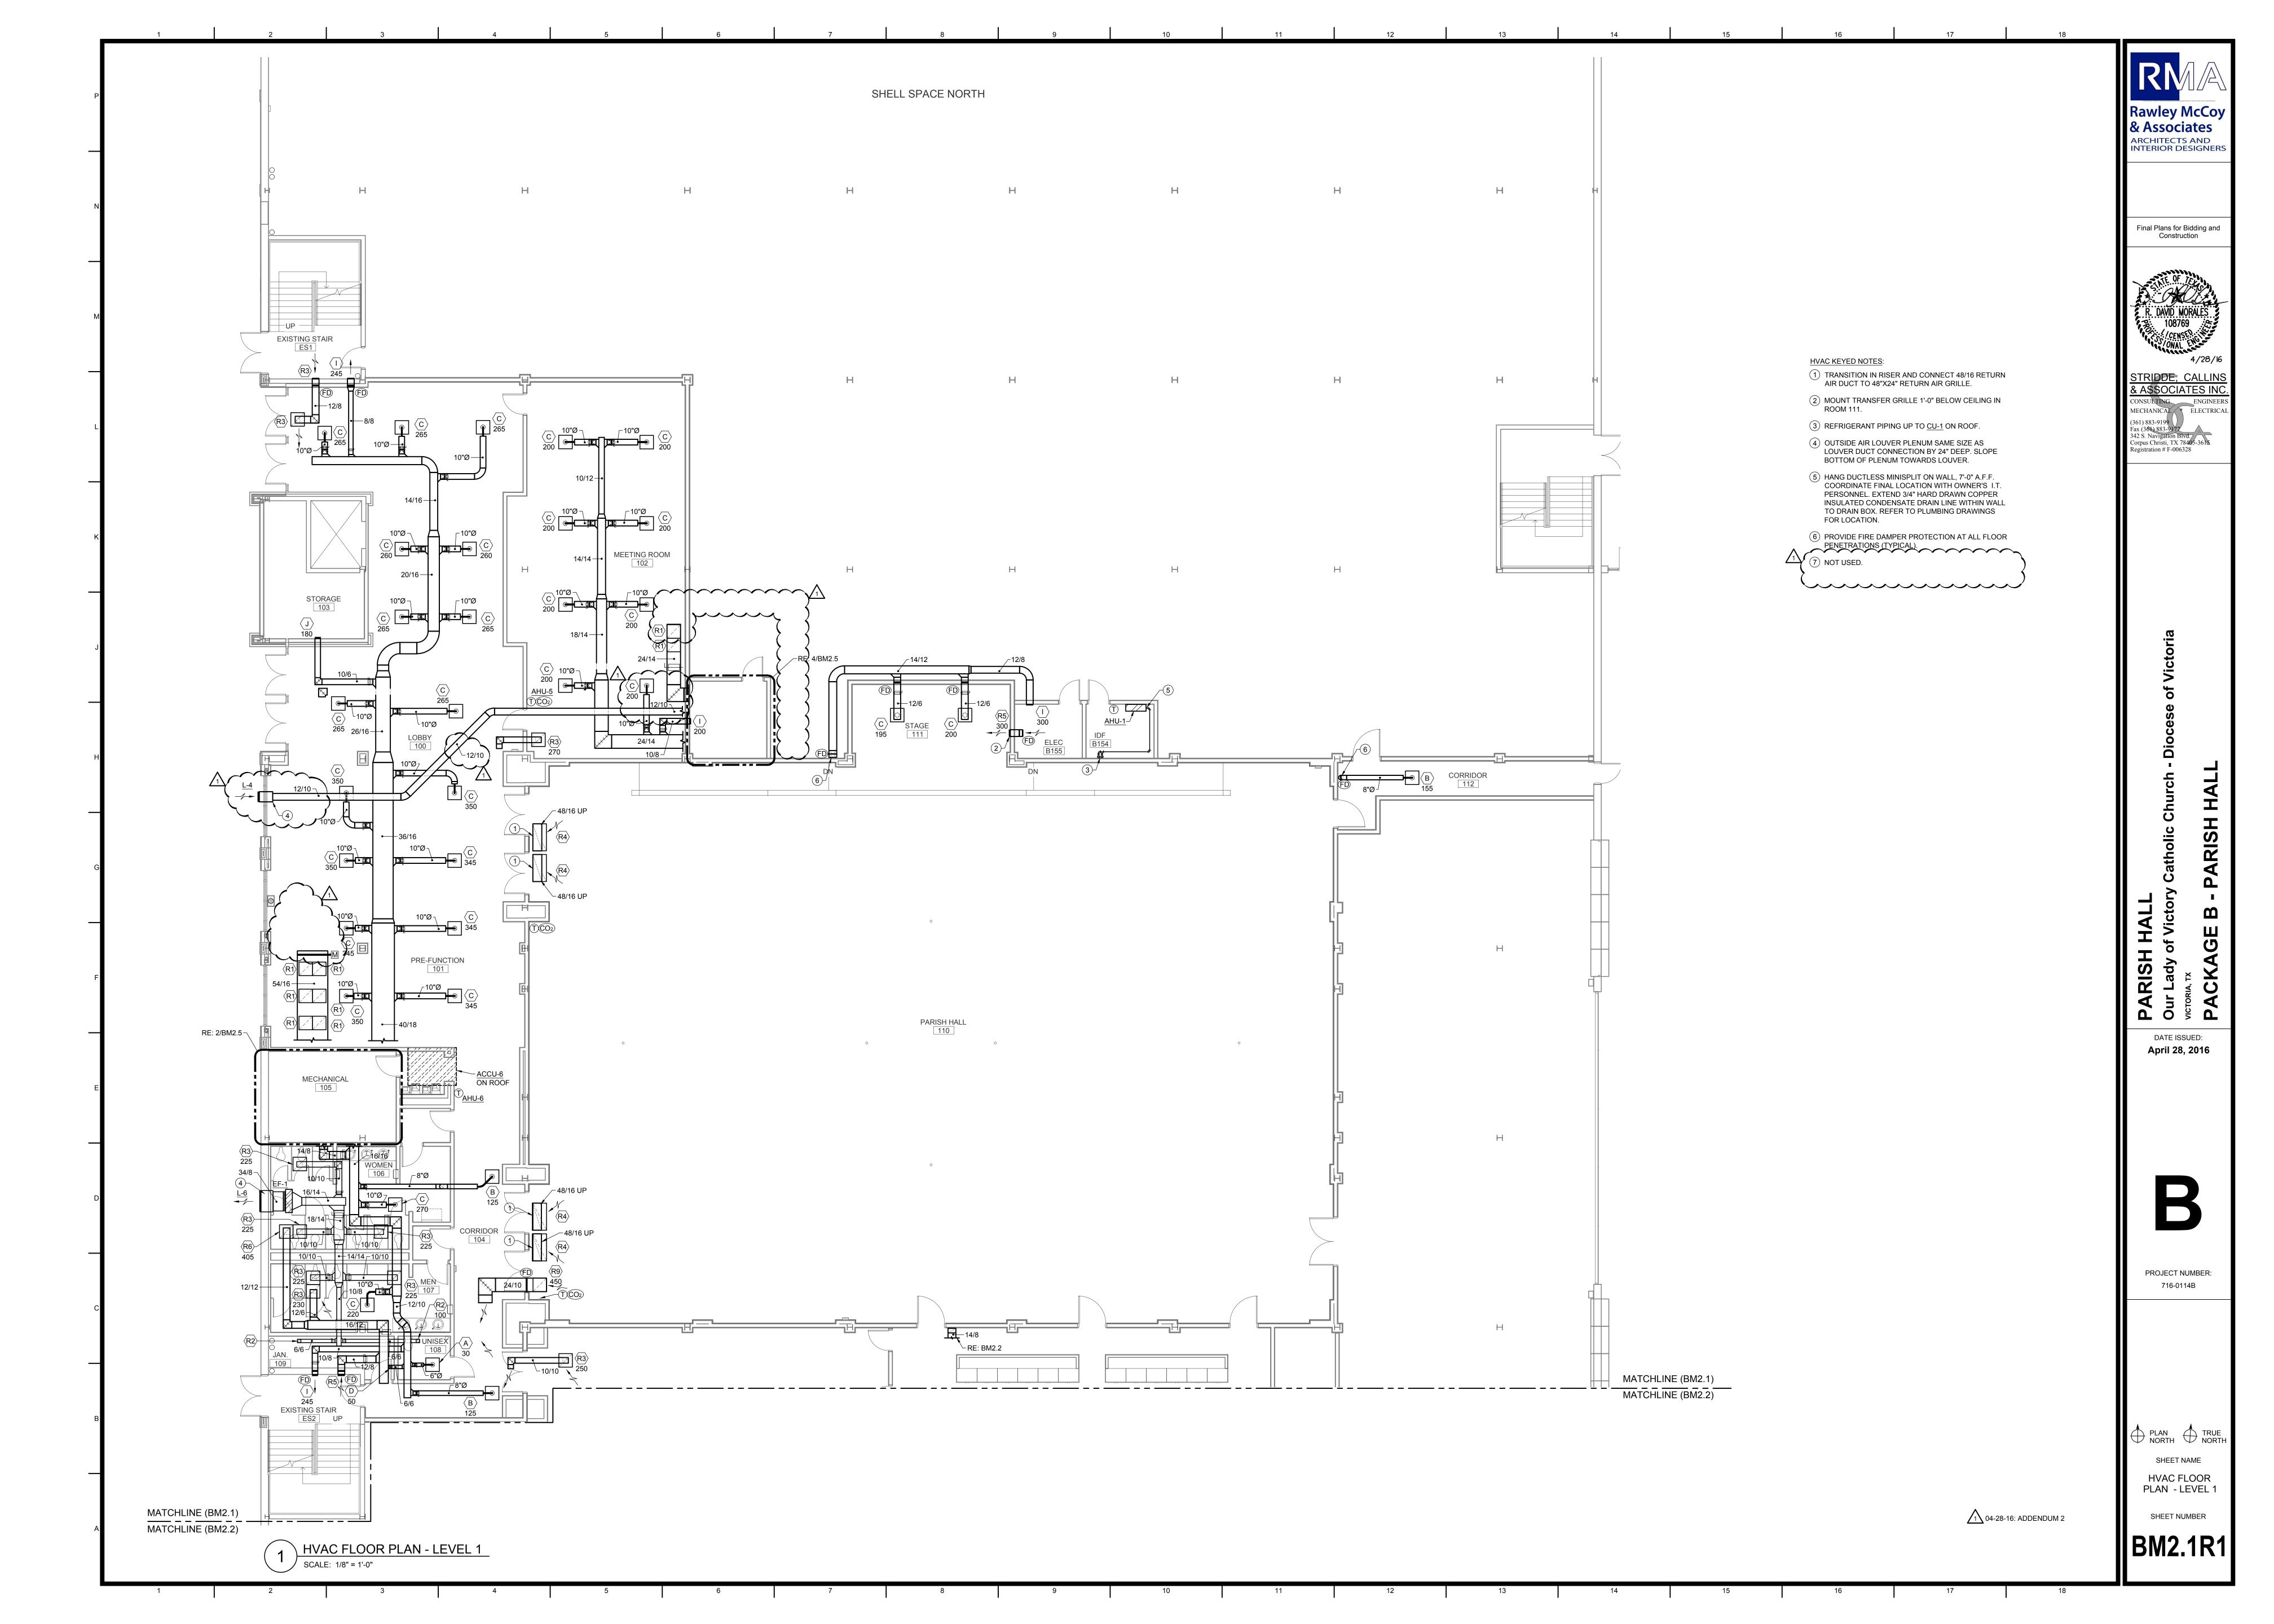

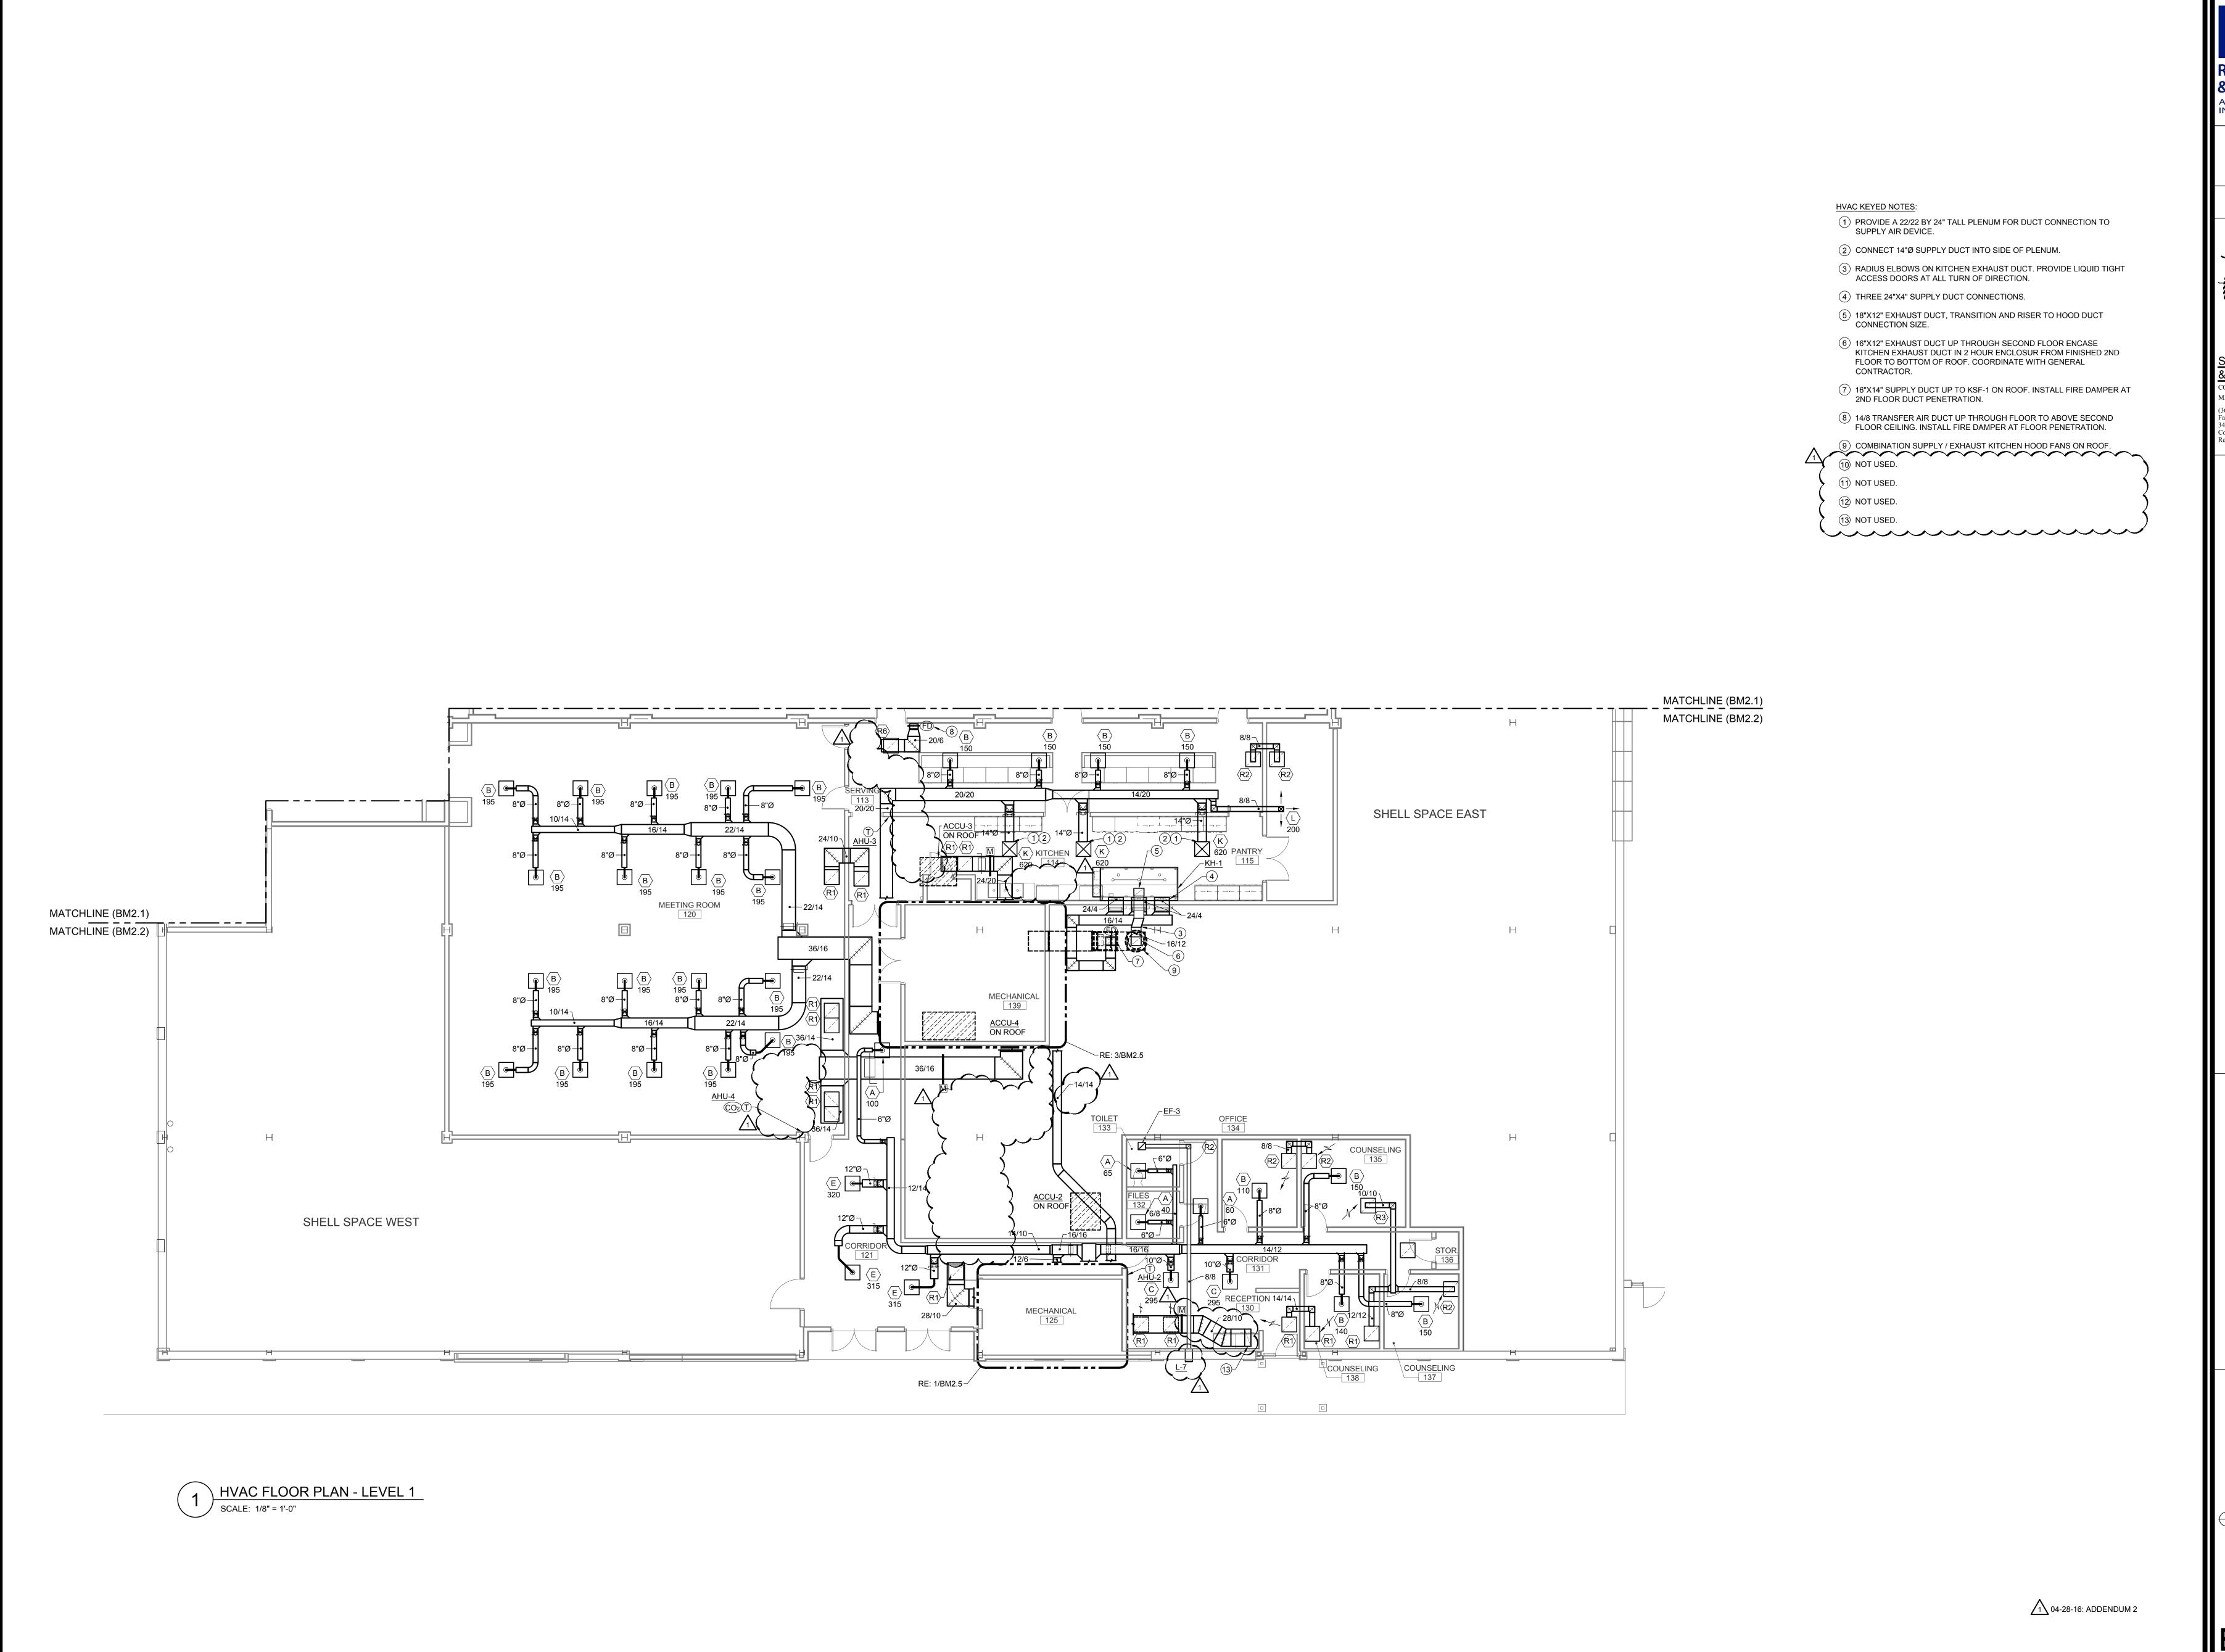

& Associates ARCHITECTS AND INTERIOR DESIGNERS

Final Plans for Bidding and Construction

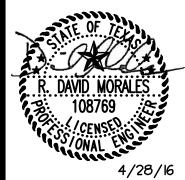

STRIDDE, CALLINS

& A\$\$OCIATES INC CONSULTING ENGINEERS
MECHANICAL * ELECTRICAL Fax (361) 883-9177
342 S. Navigation Blvd.
Corpus Christi, TX 78405-3618
Registration # F-006328


DATE ISSUED:


April 28, 2016


PROJECT NUMBER: 716-0114B

PLAN TRUE NORTH HVAC FLOOR PLAN - LEVEL 1

SHEET NUMBER

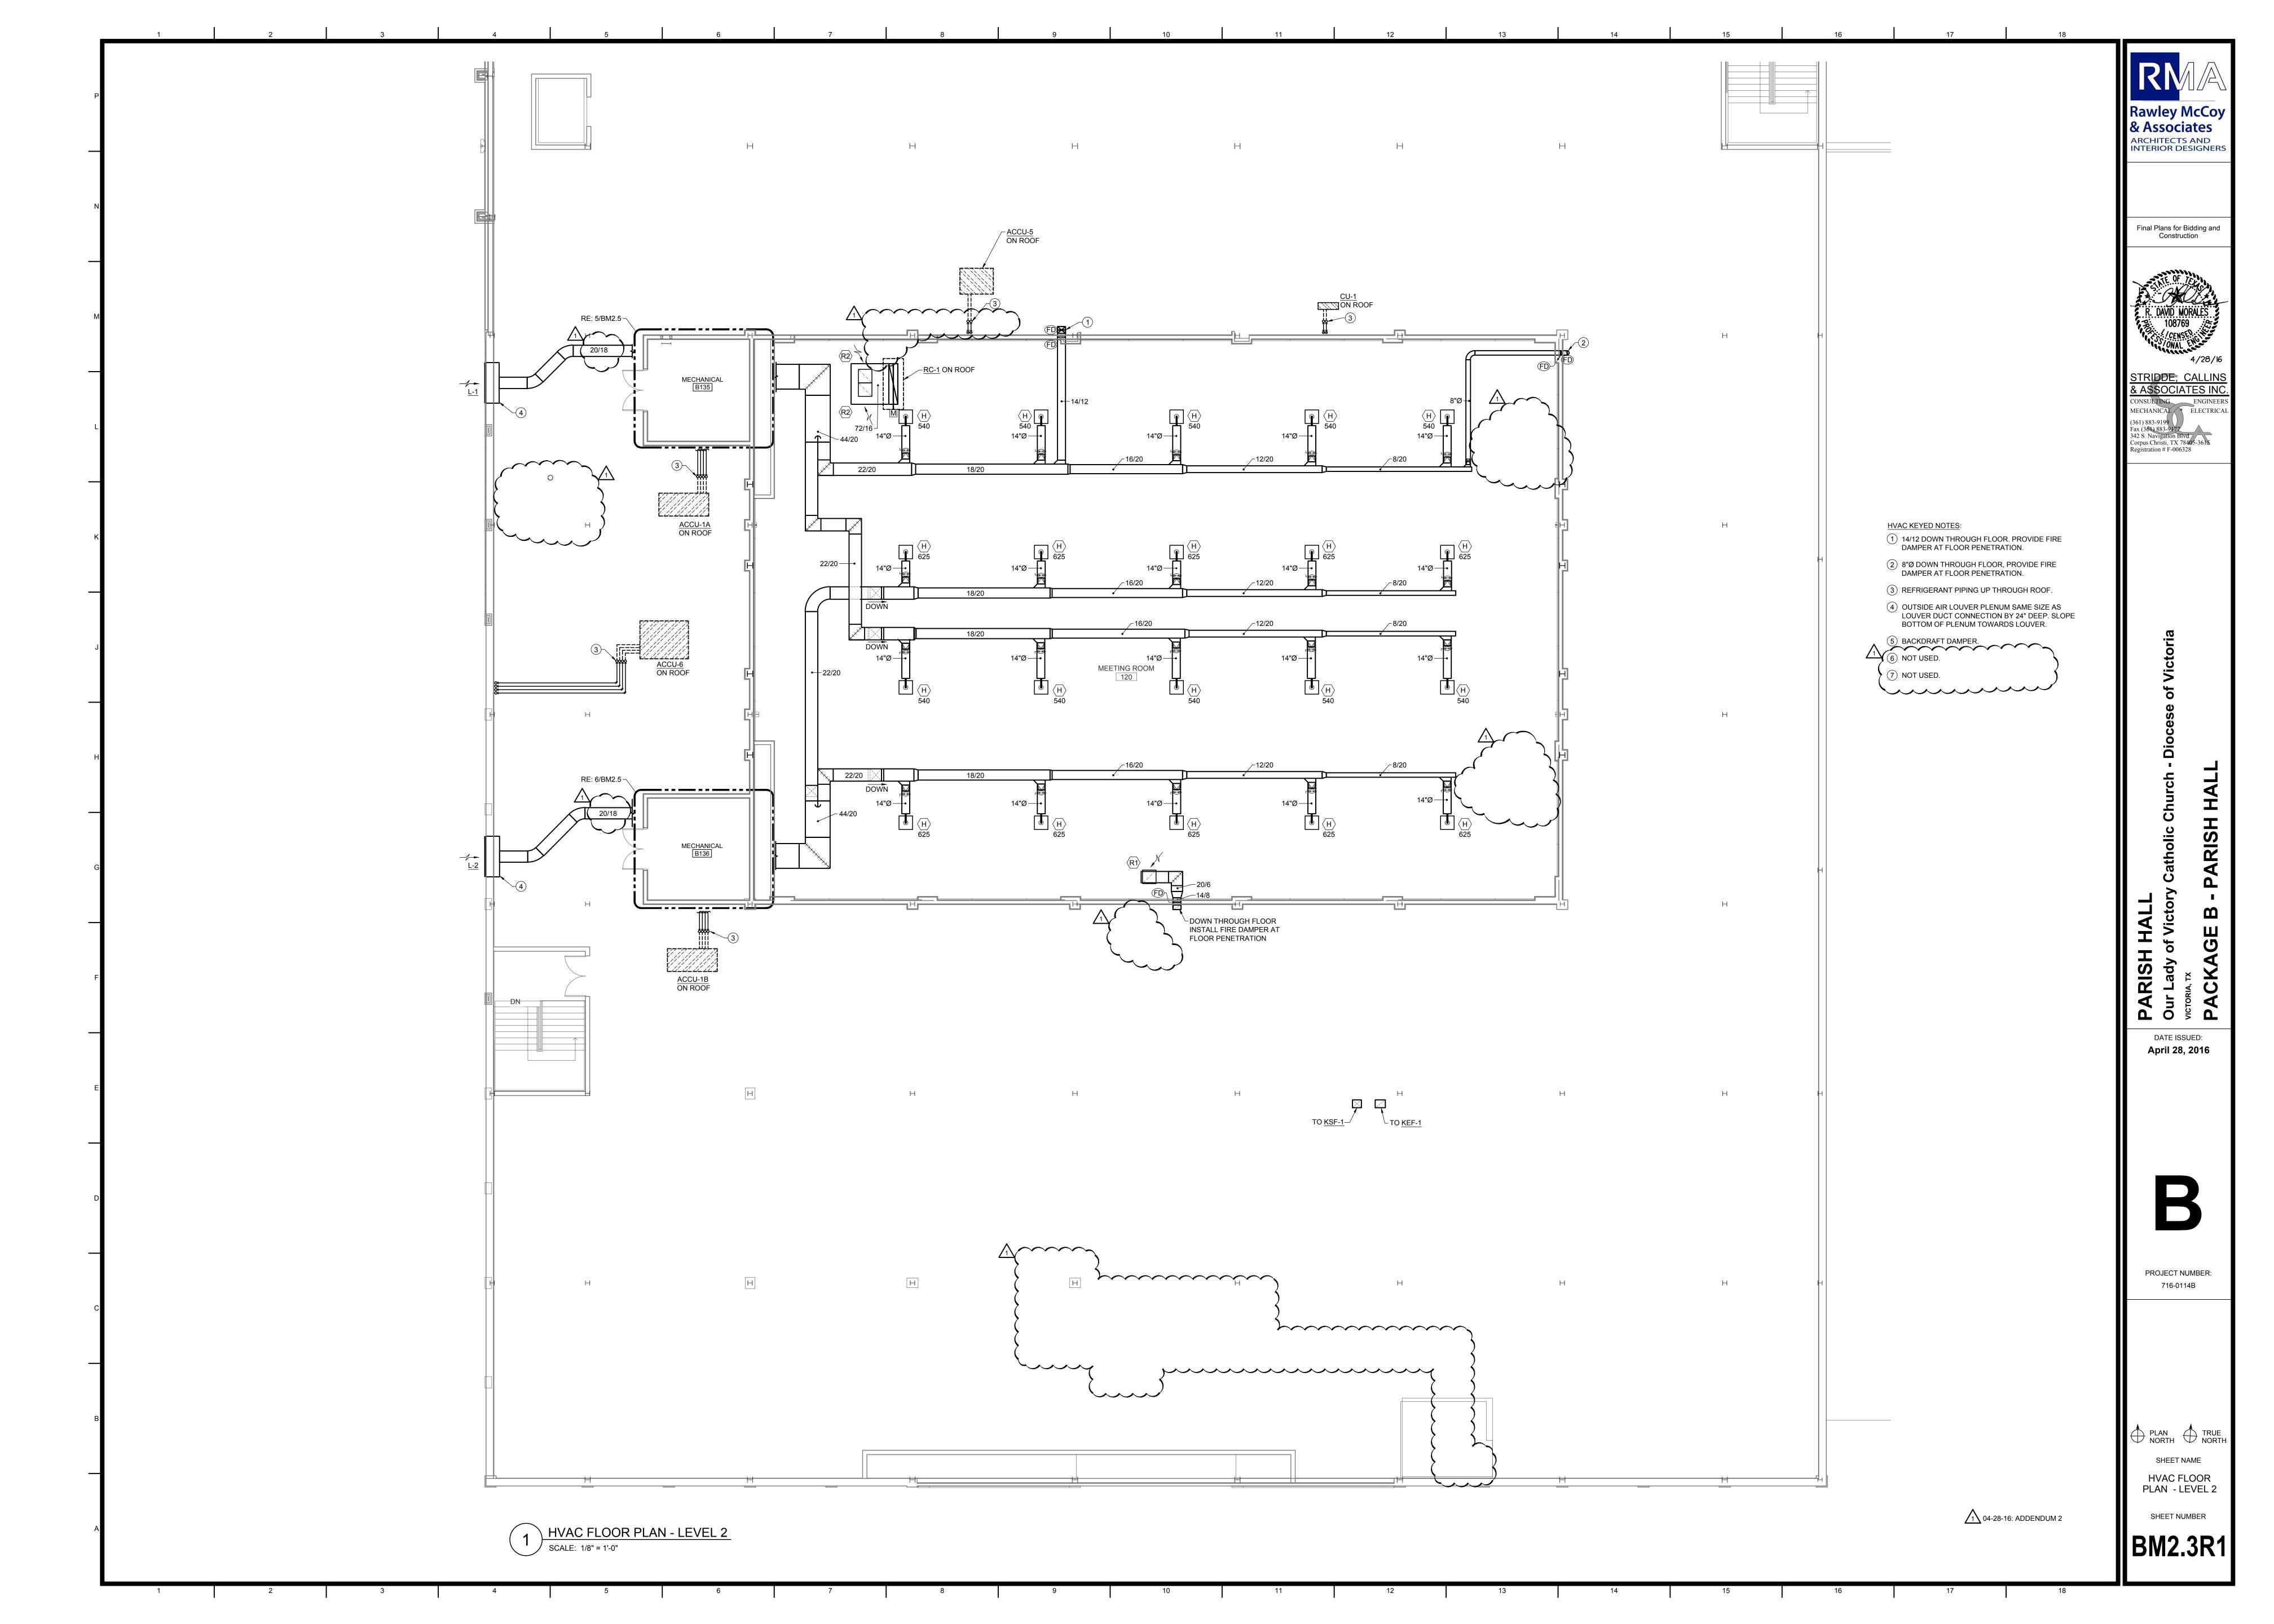

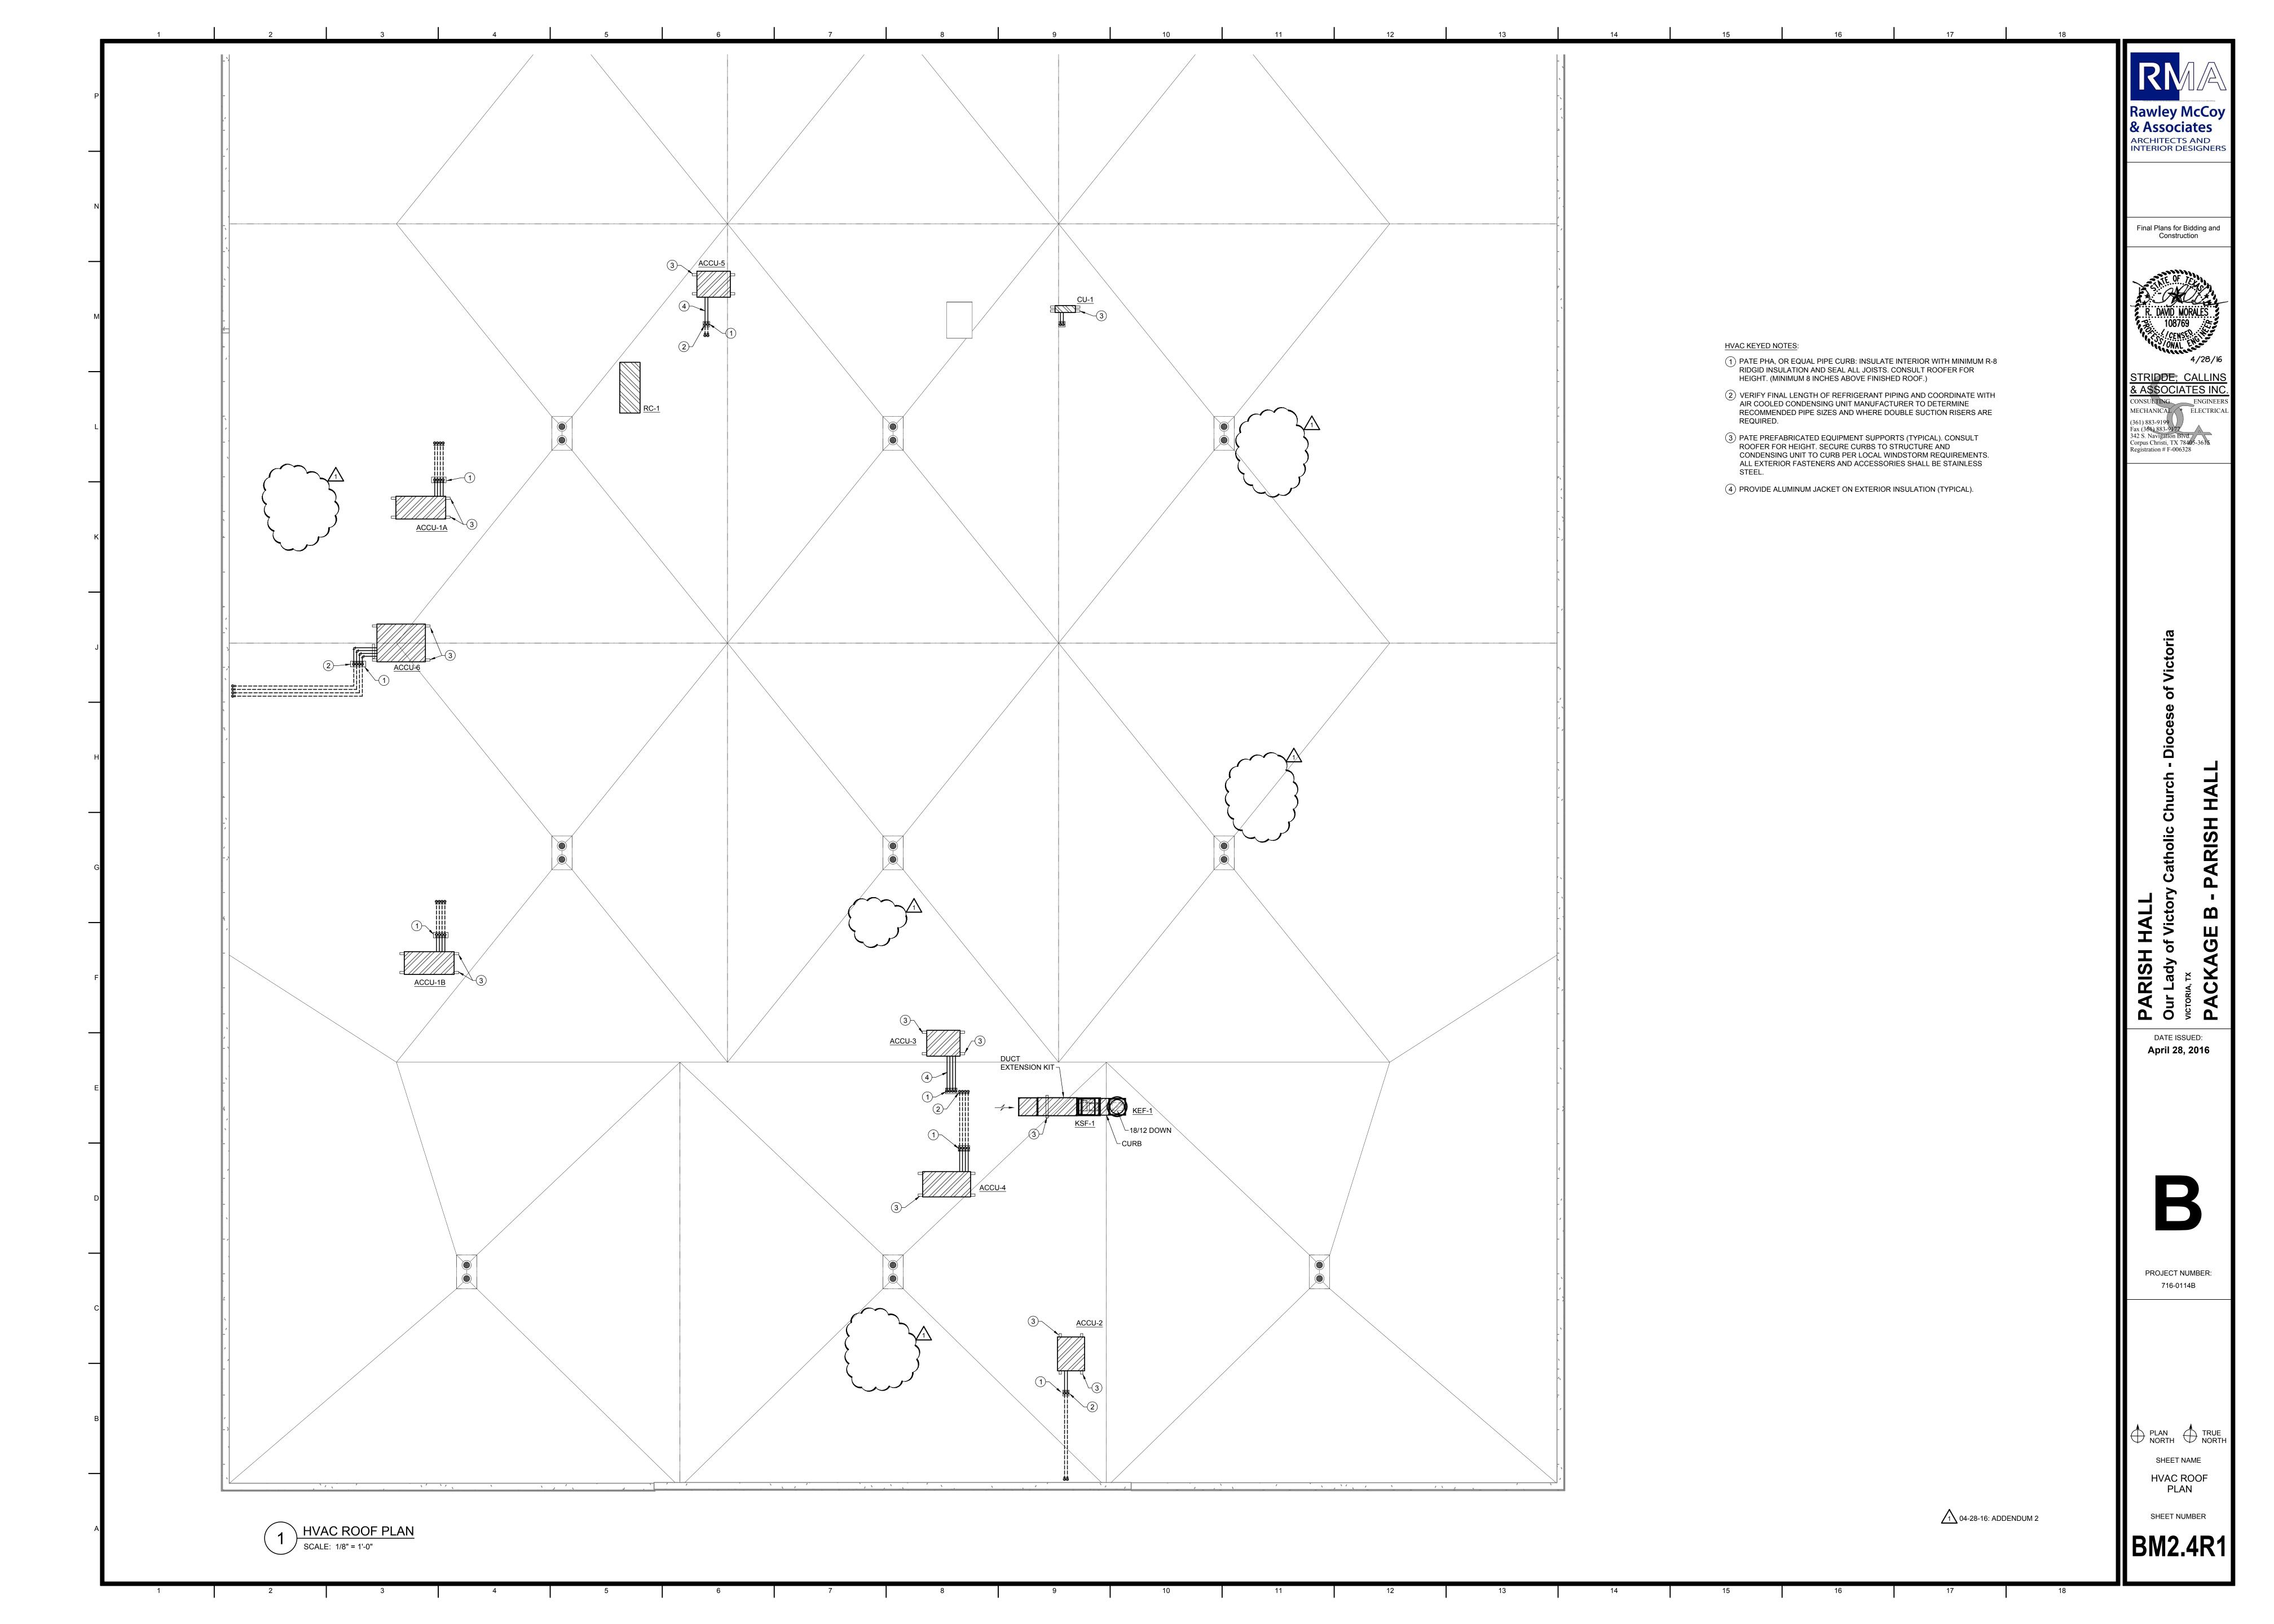

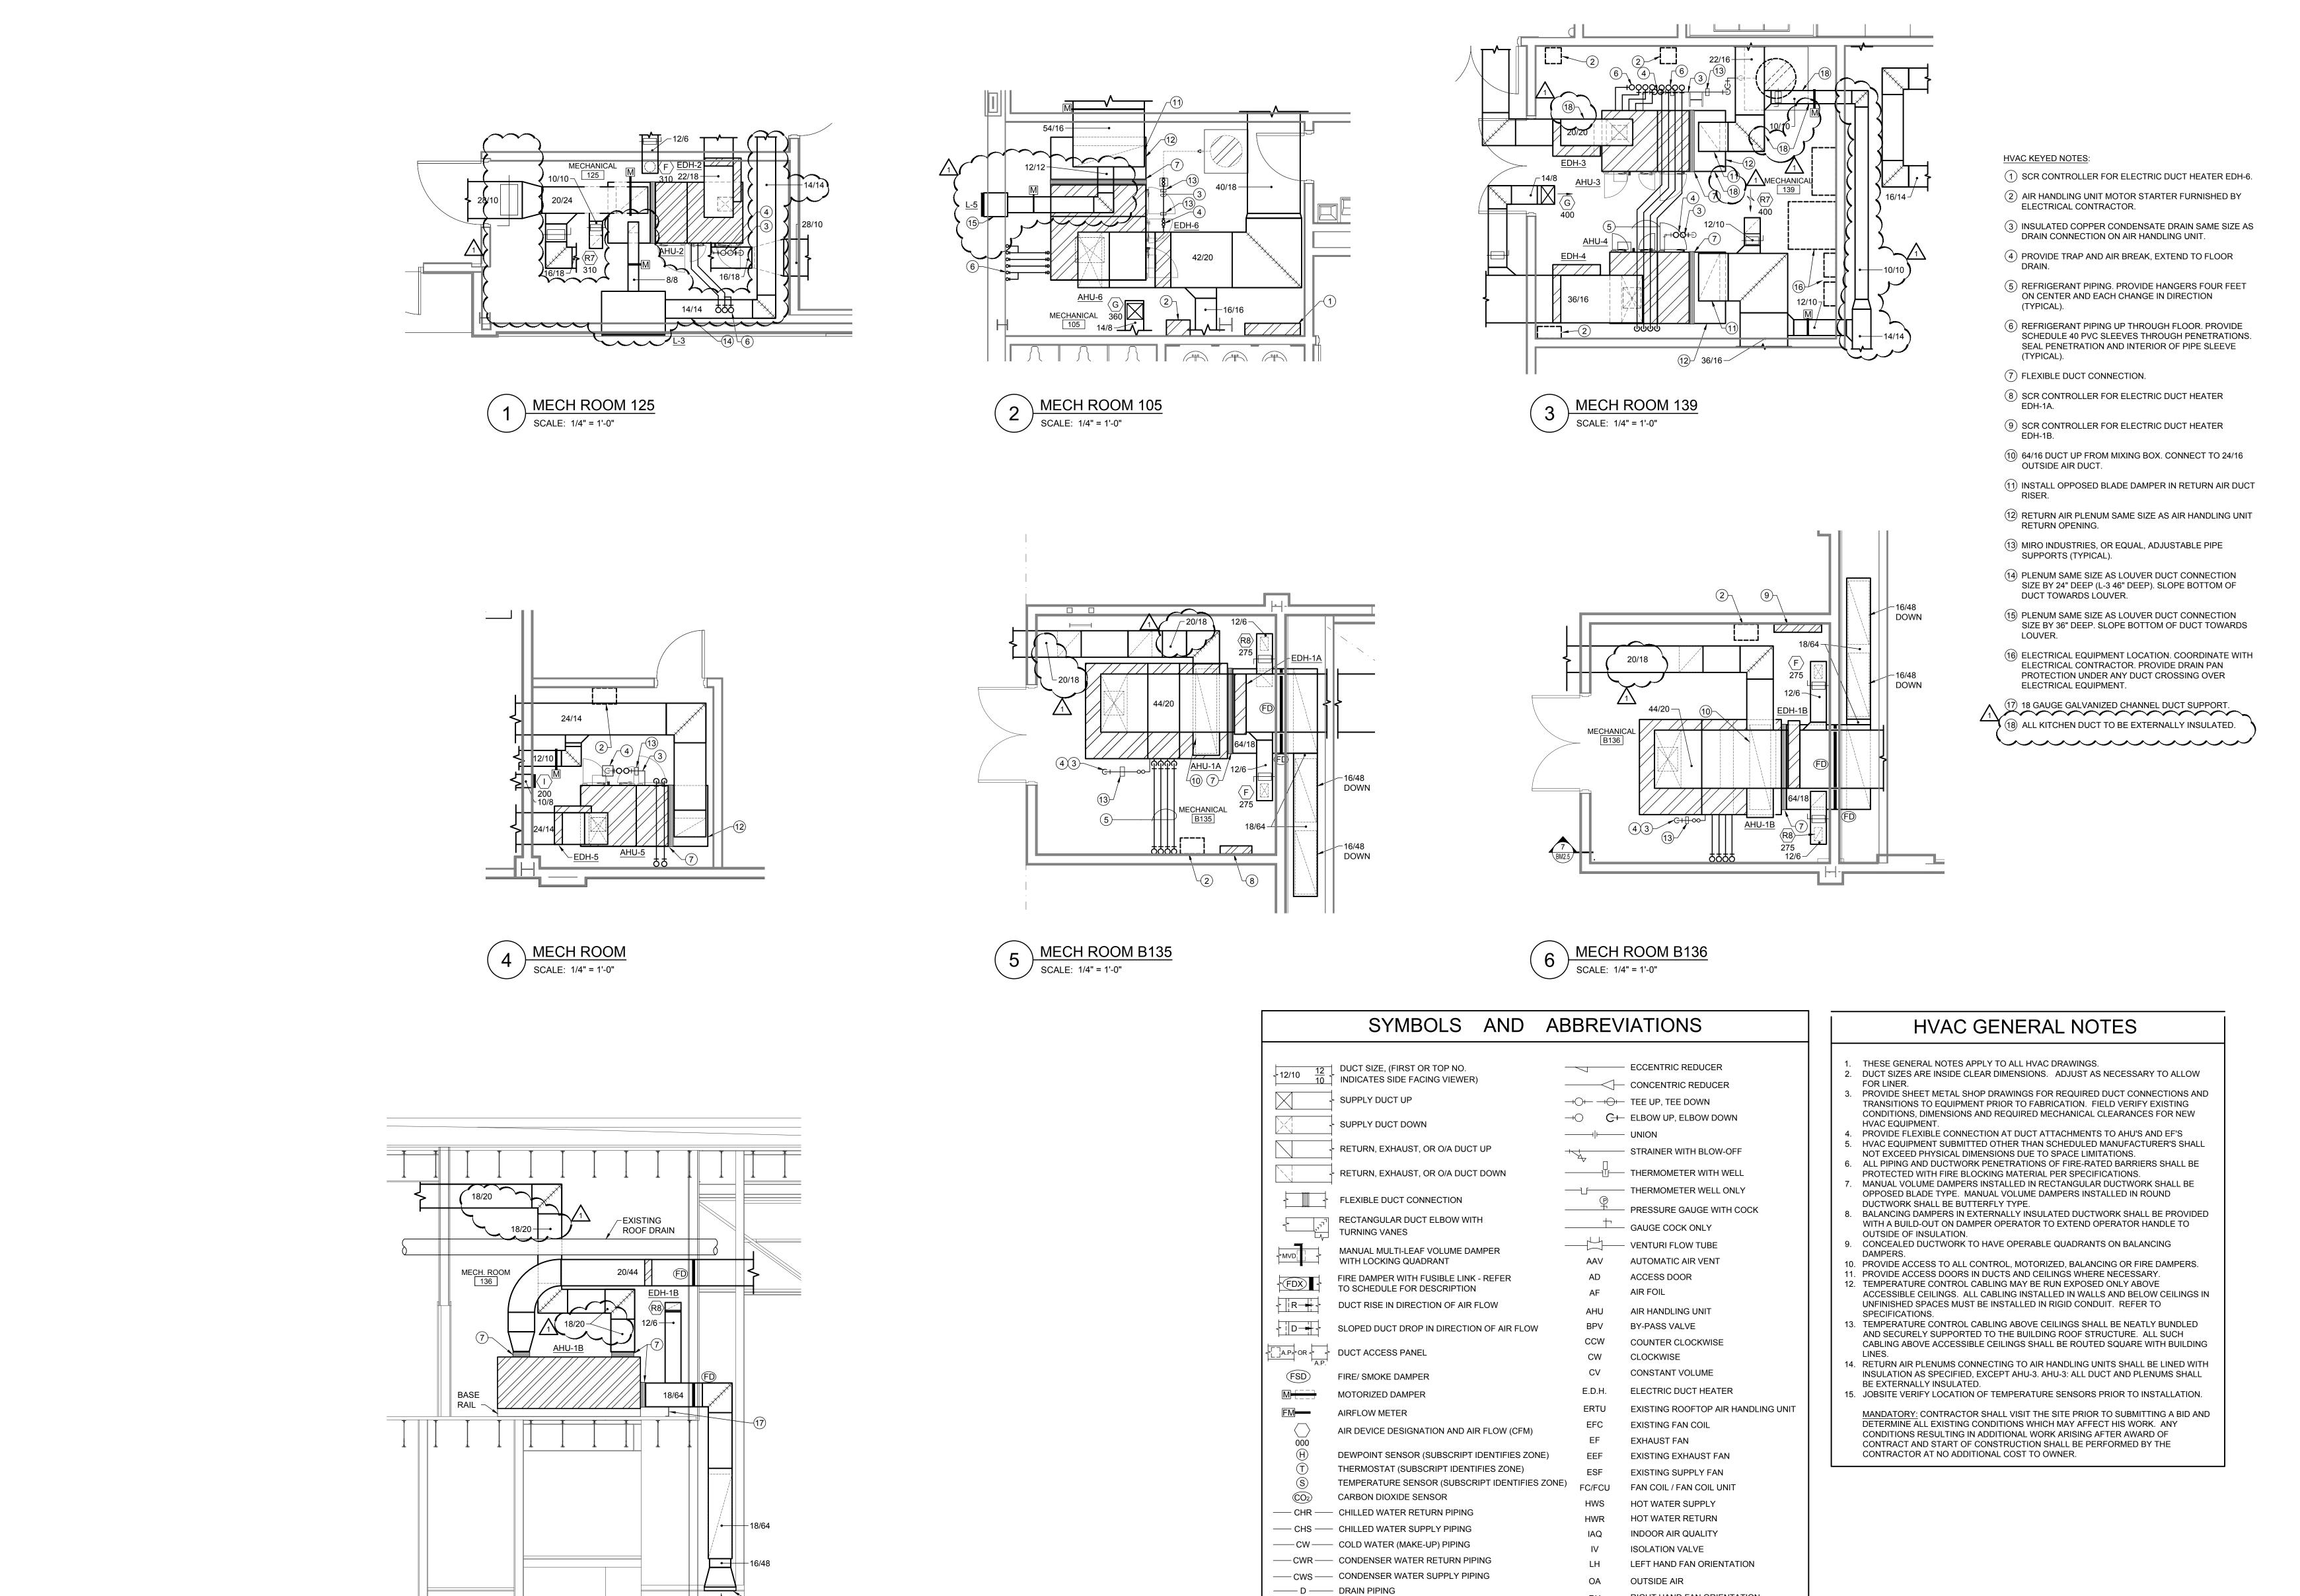

(2) 3125 EACH

7 SECTION
SCALE: 1/4" = 1'-0"

GATE VALVE

—— BALL VALVE

CHECK VALVE

 $-|\dot{|}|-$ - BUTTERFLY VALVE

CONTROL VALVE, TWO WAY


CONTROL VALVE, THREE WAY

PRESSURE-RELIEF VALVE

AUTOMATIC AIR VENT

Rawley McCoy & Associates **ARCHITECTS AND** INTERIOR DESIGNERS

Final Plans for Bidding and Construction

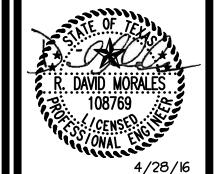

STRIDDE, CALLINS & A\$\$OCIATES INC MECHANICAL * ELECTRICA

Fax (361) 883-9177
342 S. Navigation Blvd.
Corpus Christi, TX 78405-3618
Registration # F-006328

1 04-28-16: ADDENDUM 2

RIGHT HAND FAN ORIENTATION

ROOFTOP AIR HANDLING UNIT

SUPPLY FAN

STAINLESS STEEL

UPBLAST FRONT

UPBLAST REAR

WP WEATHERPROOF

* THIS IS A GENERAL LEGEND. ALL SYMBOLS AND ABBREVIATIONS MAY NOT APPLY TO THIS PROJECT.

UNIT VENTILATOR

VARIABLE AIR VOLUME

VARIABLE FREQUENCY DRIVE

PLAN TRUE NORTH

PROJECT NUMBER:

716-0114B

DATE ISSUED:

April 28, 2016

SHEET NAME 1/4" SCALE MECH ROOMS, SYMBOLS ABBRV. & GENERAI NOTES SHEET NUMBER

|| BM2.5R1

DESIG.	NECK SIZE	TYPE	SERVICE	OBVD DAMPER	MOUNTING	MANUFACTURER & REMARKS
A	6"Ø	DIFFUSER	SUPPLY	NO	LAY-IN	TITUS TMS-AA, 360° DISCHARGE, ALUMINUM CONSTRUCTION, 24" X 24" LAY-IN PANEL, WHITE FINISH
⟨B⟩	8"Ø	DIFFUSER	SUPPLY	NO	LAY-IN	TITUS TMS-AA, 360° DISCHARGE, ALUMINUM CONSTRUCTION, 24" X 24" LAY-IN PANEL, WHITE FINISH
(c)	10"Ø	DIFFUSER	SUPPLY	NO	LAY-IN	TITUS TMS-AA, 360° DISCHARGE, ALUMINUM CONSTRUCTION, 24" X 24" LAY-IN PANEL, WHITE FINISH
D	6"x6"	GRILLE	SUPPLY / EXHAUST	NO	DUCT	TITUS TDC-AA, 2-WAY DISCHARGE, BORDER TYPE I ALUMINUM CONSTRUCTION WHITE FINISH
(E)	12"Ø	DIFFUSER	SUPPLY	NO	LAY-IN	TITUS TMS-AA, 360° DISCHARGE ALUMINUM CONSTRUCTION 24"X24" LAY-IN PANEL WHITE FINISH
⟨F⟩	12"x10"	GRILLE	SUPPLY	YES	DUCT	TITUS TDC-AA - ONE WAY DISCHARGE, ALUMINUM CONSTRUCTION
G	12"X12"	GRILLE	SUPPLY	YES	DUCT	TITUS TDC-AA - ONE WAY DISCHARGE, ALUMINUM CONSTRUCTION
$\langle H \rangle$	14"Ø	DIFFUSER	SUPPLY	NO	LAY-IN	TITUS TMS-AA 360° DISCHARGE, 24X24 LAY IN PANEL, ALUMINUM CONSTRUCTION, WHITE FINISH
	12"X8"	DIFFUSER	SUPPLY	NO	SIDEWALL	TITUS 300FS DOUBLE DEFLECTION, ALUMINUM CONSTRUCTION, WHITE FINISH
J	10"X6"	DIFFUSER	SUPPLY	NO	SIDEWALL	TITUS 300FS DOUBLE DEFLECTION, ALUMINUM CONSTRUCTION, WHITE FINISH
⟨K⟩	22"x22"	GRILLE	SUPPLY TO PLENUM	NO	LAY-IN	TITUS PAR-AA LAY-IN 24"X24" PANEL BORDER TYPE 3, ALUMINUM CONSTRUCTION
⟨L⟩	8"X8"	DIFFUSER	SUPPLY	NO	DUCT	TITUS TDC-AA, 3-WAY DISCHARGE BOULDER TYPE, ALUMINUM CONSTRUCTION, WHITE FINISH
(R1)	22"x22"	GRILLE	RETURN	NO	LAY-IN	TITUS 50F, ALUMINUM CONSTRUCTION, WHITE FINISH, 24"X24" PANEL
(R2)	8"x8"	GRILLE	RETURN/ TRANSFER	NO	LAY-IN	TITUS 50F, 35° DEFLECTION, ALUMINUM CONSTRUCTION, WHITE FINISH, 24"X24" PANEL
(R3)	10"x10"	GRILLE	RETURN/ EXHAUST	NO	LAY-IN	TITUS 50F, ALUMINUM CONSTRUCTION, 24"X24" PANEL, WHITE FINISH
(R4)	48"X24"	GRILLE	RETURN	NO	SURFACE	TITUS 350RL, 3/4" SPACING 35° FIXED DEFLECTION WHITE FINISH
(R5)	12"X12"	GRILLE	RETURN	NO	DUCT/ SIDEWALL	TITUS 350RL, 3/4" SPACING 35° FIXED DEFLECTION WHITE FINISH
(R6)	16"X16"	GRILLE	TRANSFER	NO	LAY-IN	TITUS 50F, 24"X24" PANEL, WHITE FINISH
(R7)	10"X10"	GRILLE	RETURN	NO	DUCT MOUNTED	TITUS 355FL 1/2" SPACING, 35° DEFECTION ALUMINUM CONSTRUCTION
(R8)	12"X8"	GRILLE	RETURN	NO	DUCT/ SURFACE	TITUS 355FL 1/2" SPACING, 35° DEFECTION. ALUMINUM CONSTRUCTION
(R9)	24"X24"	GRILLE	TRANSFER	NO	SURFACE	TITUS 350FL, 3/4" SPACING 35° DEFLECTION ALUMINUM CONSTRUCTION

THE ARCHITECT CEILING TYPES. SEE ARCHITECTURAL DRAWINGS FOR COORDINATION. CONFIRM AIR DEVICE COLOR WITH ARCHITECT. 4. ON ALL REGISTERS, PROVIDE CONCEALED FRAME MOUNTING. NO SCREWS SHALL BE IN FACE OF FRAME.

5. NECK SIZE IS NOTED ON THE DRAWINGS AND SHALL BE THE SAME SIZE AS THE DUCT RUNOUT TO THE

ROOF CAP SCHEDULE								
DESIG.	THROAT SIZE (IN)	HOOD AREA (FT²)	HEIGHT (IN.)	SERVES	TYPE	MANUFACTURER & MODEL NO.		
RC-1	16"X72"	8	11	AHU-1A & AHU-1B	O.A. RELIEF	COOK VR		
NOTES:			•					

2. PROVIDE MOTORIZED DAMPER INTERLOCKING WITH AHU-1A AND AHU-1B ECONOMIZER CYCLE.

. FURNISH WITH 14" HIGH INSULATED ROOF CURB.

DIFFUSER.

ELECTRIC DUCT HEATER SCHEDULE									
MARK	SERVES	KW	NUMBER OF STAGES	V/P/H	EAT °F	LAT °F	CFM	MANUFACTURER & MODEL NO.	
EDH-1A,1B	AHU-1A,1B	56	SCR	460/3/60	58.4	85.6	6650	REDDI MODEL RN	
EDH-2	AHU-2	16	2	460/3/60	67.7	86.7	2665	REDDI MODEL R	
EDH-3	AHU-3	18	2	460/3/60	64.9	86.6	2660	REDDI MODEL R	
EDH-4	AHU-4	23	2	460/3/60	64.9	83.5	3910	REDDI MODEL R	
EDH-5	AHU-5	12	2	460/3/60	62.4	85	1800	REDDI MODEL R	
EDH-6	AHU-6	52	SCR	460/3/60	67.4	90.8	7005	REDDI MODEL RN	

NOTES: (APPLY TO ALL EDH'S UNLESS OTHERWISE NOTED)

- MAINTAIN NATIONAL ELECTRICAL CODE CLEARANCES IN FRONT OF HEATER CONTROL PANEL.
- MAINTAIN MANUFACTURER'S RECOMMENDED DISTANCES TO COMBUSTIBLES. PROVIDE MANUFACTURER'S RECOMMENDED MOUNTING HARDWARE.
- . MAXIMUM AIRSIDE PRESSURE LOSS 0.10". 5. PROVIDE 24V CONTROLS WITH TRANSFORMER.
- 6. PROVIDE INSULATED TERMINAL BOX.
- PROVIDE SAFETY AND OPERATING CONTROLS PER NEC. 8. EXTERNALLY INSULATE ALL SURFACES SUBJECT TO CONDENSATION.
- 9. FUSING SHALL BE BY STAGES. 10. SINGLE POINT WIRING CONNECTION.

EDH-6.

11. SLIP-IN, OPEN ELEMENT TYPE. 12. PROVIDE SAFETY DISCONNECT SWITCH, AIRFLOW SWITCH, HIGH TEMPERATURE CUTOUT. 13. PROVIDE WALL MOUNTED REMOTE S.C.R. CONTROL TERMINAL BOX FOR EDH-1A, EDH-1B, AND

\rightarrow											
(LOUVER SCHEDULE										
\ \ \	DESIG.	SIZE (W x H)	NET FREE AREA (FT²)	TYPE	CFM	SERVES	MANUFACTURER & MODEL NO.				
\	L-1	42X24	3.48	INTAKE	1890	AHU-1A	RUSKIN ELF6375DXD				
	L-2	42X24	3.48	INTAKE	1890	AHU-1B	RUSKIN ELF6375DXD				
(L-3	48X18	3.15	INTAKE	940	AHU-2, 3, & 4	RUSKIN ELF6375DXD				
	L-4	18X18	0.93	INTAKE	320	AHU-5	RUSKIN ELF6375DXD				
(L-5	18X18	0.93	INTAKE	450	AHU-6	RUSKIN ELF6375DXD				
>	L-6	42X18	2.32	EXHAUST	1200	EF-1	RUSKIN ELF6375DXD				
(L-7	12X18	0.58	EXHAUST	100	EF-3	RUSKIN ELF6375DXD				

PROVIDE BIRD SCREEN. COORDINATE FINISH AND FRAME CONSTRUCTION WITH ARCHITECT.

DESIG. CFM E.S.P. H.P.

COORDINATE MOUNTING HEIGHT WITH ARCHITECT. PROVIDE DRAIN ABOVE BLADES AND EXTERIOR SILL.

	AIR HANDLING UNIT SCHEDULE - DIRECT EXPANSION																
		FAN				COOLING COIL						ELECTRICAL				MANUEACTURER	
MARK	SUPPLY CFM	OUTDOOR AIR CFM	E.S.P. IN. WG	MOTOR H.P.	TOTAL CAPACITY MBH	SENSIBLE CAPACITY MBH	ENTERING AIR DB/WB (°F)	LEAVING AIR DB/WB (°F)	ROWS	FINS PER INCH	FACE AREA SQ/.FT.	FAN FLA	MCA	МОСР	V/P/H	MANUFACTURER & MODEL NO.	
AHU-1A,1B	6650	1890	1.06	7.5	318.4	186.8	80.4/69.4	54.2/54	8	11	14.34	9.3	11.6	20	460/3/60	CARRIER 39M 014	
AHU-2	2665	155	1.00	3	84.8	65.3	76.0/63.3	53.6/52.3	4	14	5.9	3.9	4.9	6	460/3/60	CARRIER 39M 06	
AHU-3	2660	335	1.00	2	96.7	70.6	77.4/64.3	52.8/51.7	6	8	5.9	2.8	3.5	6	460/3/60	CARRIER 39M 06	
AHU-4	3910	450	1.00	5	165.8	101.3	77.4/67	53.7/53.1	6	11	7.64	6.5	8.1	10	460/3/60	CARRIER 39M 08	
AHU-5	1800	320	1.00	1.5	82.3	47	78.5/68.3	52.9/52.3	6	8	4.13	2.1	2.6	3	460/3/60	CARRIER 39M 06	
ΔHIL6	7005	450	1.00	7.5	226	175.7	76/63 4	53 2/52 30	6	11	14 34	9.4	11.8	20	460/3/60	CARRIER 30M 014	

NOTES:

- 1. MAINTAIN MANUFACTURER'S RECOMMENDED DISTANCES FOR
- MAINTENANCE. 2. PROVIDE 2" THICK, MERV-8 FILTER.
- 3. PROVIDE 6" HIGH BASE RAILS.
- 4. PROVIDE STAINLESS STEEL DRAIN PANS.
- 5. PROVIDE SPRING ISOLATION FOR FAN MOTOR.
- 6. PROVIDE FILTER MIXING BOX AT AHU-1A AND AHU-1B 7. PROVIDE ANGLE FILTER SECTION FOR AHU-2 THROUGH AHU-6.
- 8. PROVIDE EXPANSION VALVE AT EACH COIL. 9. AHU-1A,1B,3,5: PROVIDE CO2 SENSOR MOUNTED ADJACENT TO
- THERMOSTAT OR COMBINATION CO2 SENSOR THERMOSTAT AND DEMAND CONTROL VENTILATION SEQUENCE.

0/63.3	53.6/52.3	4	14	5.9	3.9	4.9	6	460/3/60	CARRIER 39M 06	1690
4/64.3	52.8/51.7	6	8	5.9	2.8	3.5	6	460/3/60	CARRIER 39M 06	1430
7.4/67	53.7/53.1	6	11	7.64	6.5	8.1	10	460/3/60	CARRIER 39M 08	1710
5/68.3	52.9/52.3	6	8	4.13	2.1	2.6	3	460/3/60	CARRIER 39M 06	1450
6/63.4	53.2/52.39	6	11	14.34	9.4	11.8	20	460/3/60	CARRIER 39M 014	2430

10. PROVIDE MANUFACTURER'S 7-DAY PROGRAMMABLE DIGITAL

THERMOSTAT WITH AUXILIARY OUTSIDE AIR DAMPER CONTACT AND

. AHU-1A, 1B: PROVIDE FACTORY MIXING BOX WITH RETURN AND

OUTSIDE AIR DAMPERS. HVAC CONTRACTOR SHALL PROVIDE MODULATING ACTUATORS FIELD INSTALLED.

	DUCTLESS MINI-SPLIT SYSTEM													
DESIG.		SENSIBLE	LATENT	TOTAL	REF LINE SIZES ELECTRICAL DATA					INDOOR UNIT	R OUTDOOR UNIT	MANUFACTURER		
	CFM	CAPACITY (BTU/HR)	CAPACITY (BTU/HR)	CAPACITY (BTU/HR)	LIQUID	GAS	RLA	SEER @ ARI	SYSTEM MCA	SYSTEM MOCP	V/P/H	WEIGHT (LBS)	WEIGHT (LBS)	& MODEL NO.
H-1/CU-1	194	5,490	3,300	8,790	3/8"	1/2"	2.9	18.0	8.0	15.0	208/1/60	20	75	DAIKIN INDOOR/OUTDOOR FTX09LVJU/RXS09LVJU
											•			

- PROVIDE INTEGRAL FACTORY INSTALLED AND WIRED CONTROLS: FAN CONTACTOR, LOW VOLTAGE TRANSFORMER, CONTROL WIRING TERMINAL STRIP AND DISCONNECT.
- MAINTAIN MANUFACTURER'S RECOMMENDED DISTANCES FOR MAINTENANCE.
- PROVIDE CONDENSATE DRAIN P-TRAP AT DRAIN OUTLET. PROVIDE FACTORY PROGRAMMABLE, DIGITAL THERMOSTAT.
- PROVIDE LOW AMBIENT CONTROL DOWN TO 0°F. REFRIGERANT LINE SIZES SHOWN FOR REFERENCE ONLY. PROVIDE REFRIGERANT LINE SIZES AND INSTALLATION PER MANUFACTURER'S RECOMMENDATIONS.
- PROVIDE FACTORY APPLIED CONDENSER COIL COATINGS. THREE SPEED FAN.
- MAXIMUM 35dB. VARIABLE SPEED, DIGITAL INVERTER COMPRESSOR.
- HIGH AND LOW PRESSURE SAFETY. INDOOR COIL FREEZE PROTECTION.
- 14. AUTOMATIC RESTART AFTER POWER INTERRUPTION. 15. INSULATE BOTH REFRIGERANT LIQUID AND GAS LINES.

★ COOLING CAPACITIES AT 95°F AMBIENT, 76°F	
DB/63°F UB INDOOR CONDITIONS	

PIPING MATERIALS: 1. REFRIGERANT: ASTM B280, TYPE ACR HARD

WROUGHT COPPER FITTINGS. 2 CONDENSATE DRAIN: ASTM B88. TYPE L HARD

5/8" 1

5∕8"

3/8"

5/8"

DRAWN COPPER TUBING WITH ASME B16.22

2. CONDENSATE DRAIN: ASTM B88, TYPE L
DRAWN COPPER TUBING WITH ASME B16.
WROUGHT COPPER FITTINGS.

AIR COOLED CONDENSING UNIT SCHEDULE

MCA

57.8

29.9

18

40.8

18.0 25

MOCP

80

40

25

50

COMPRESSOR

RLA

23.1

12.6

12.2 EA.

12.6

16.7 EA.

		FAN SCHEDULE										
CFM E.S.P. H.P. V/P/H RPM TYPE SERVICE SONES MANUFACTURER & CONTROL WITH CURB (LBS.)												
	1325	0.30	1/2	120/1/60	823	IN	MENS/ WOMENS	3.4	COOK GC1000	A	125	1,2,3,7,10
	2100	1.3	1	460/3/60	1202	UB	KITCHEN HOOD	13.1	ACCUREX XRUD-180HP-10	В	170	1,2,3,4,5,6,8,9
	100	0.25	1/10	120/1/60	929	CD	UNISEX	1.9	COOK GC144	С	15	1,2,3,7
	1420	0.5	1/2	120/1/60	875	MU	KITCHEN	12	ACCUREX XKSEB-109-H15-01	В	365	1,2,3,5,9

KSF-1

- PROVIDE INTEGRAL BACKDRAFT DAMPER. 2. PROVIDE THERMAL PROTECTION.
- 3. PROVIDE INTERNAL DISCONNECT SWITCH, FACTORY MOUNTED. 4. PROVIDE BIRD SCREEN.
- 5. PROVIDE 14" HIGH INSULATED ALUMINUM ROOF MOUNTING CURB WITH PITCH TO MATCH ROOF SLOPE. SECURE CURB TO ROOF AND FAN TO CURB PER LOCAL WINDSTORM REQUIREMENTS. COORDINATE WITH STRUCTURAL ENGINEER. COORDINATE WITH ROOFING CONTRACTOR BEFORE SETTING CURB TO AVOID CONFLICTS WITH ROOF WARRANTY.
- 6. PROVIDE STAINLESS STEEL SCREWS TO SECURE FAN TO CURB. 7. PROVIDE WITH SPEED CONTROL MOUNTED WITHIN FAN HOUSING. 8. KEF-1: PROVIDE VENTED ROOF CURB EXTENSION, HINGED KIT WITH CABLES AND GREASE TRAP WITH DRAIN CONNECTION.
- 9. KEF-1 AND KSF-1 SHALL BE PROVIDED WITH 14" HIGH INSULATED COMBINATION SUPPLY/EXHAUST CURB, SUPPLY AIR INTAKE EXTENSION WITH SUPPORT AND WEATHER HOOD WITH ALUMINUM MESH INTAKE FILTERS.
- 10. PROVIDE HANGER KIT FOR MOUNTING ABOVE CEILING.

GENERAL NOTES: (APPLICABLE TO ALL FAN'S)

- A. MAINTAIN MANUFACTURER'S RECOMMENDED DISTANCES FOR MAINTENANCE.
- B. MAINTAIN 10' MINIMUM CLEARANCE BETWEEN OA AND EXHAUST AIR.

UB - UPBLAST CENTRIFUGAL ROOF EXHAUSTER - BELT DRIVE CD - CEILING MOUNTED CABINET EXHAUSTER - DIRECT DRIVE IN - INLINE, SUSPENDED - DIRECT DRIVE. MU - MAKE UP AIR UNIT BELT DRIVE

CONTROL:

A- INTERLOCK WITH AHU-6. B- INTERLOCK WITH SWITCH ON HOOD AND FAN CONTROL PANEL ON HOOD. C- INTERLOCK WITH AHU-2.

226 ACCU-6

OUTDOOR

AMBIENT

98

98

98

98

MARK

ACCU-1A,1B

ACCU-2

ACCU-3

ACCU-4

ACCU-5

CAPACITY

MBH

318.4

84.8

96.7

165.8

82.3

NO. OF

COMPRESSORS

V/P/H

460/3/ 60 2 EA.

460/3/60 1 EA.

460/3/60 2 EA.

460/3/60 2 EA.

460/3/60 1 EA.

460/3/60 2 EA.

- NOTES: (APPLICABLE TO ALL ACCU'S) MAINTAIN MANUFACTURER'S RECOMMENDED DISTANCES FOR MAINTENANCE. 9. PROVIDE DOUBLE SUCTION RISER WHERE RECOMMENDED BY 2. REFRIGERANT PIPE SIZE SHOWN ARE FOR REFERENCE PURPOSES ONLY.
- CONFIRM EXACT SIZES WITH MANUFACTURER AND ADJUST AS NECESSARY. COMPLETE REFRIGERANT PIPING INSTALLATION SHALL BE IN ACCORDANCE
- WITH MANUFACTURER'S RECOMMENDATIONS. B. PROVIDE SIGHT GLASS AND FILTER DRYER IN LIQUID ADJACENT TO CONDENSING UNIT IF NOT PROVIDED WITHIN UNIT.
- PROVIDE LOW AMBIENT CONTROL. PROVIDE SHORT CYCLE PROTECTION.
- 6. PROVIDE HIGH AND LOW PRESSURE SWITCHES WITH MANUAL RESET. PROVIDE CRANKCASE HEATER.

8. PROVIDE ACCUMULATOR WHEN RECOMMENDED BY MANUFACTURER.

MANUFACTURER.

5∕8"

- 10. PROVIDE FACTORY APPLIED E-COATING OR FIELD APPLIED ENERGY GUARD COATING ON CONDENSER COILS. PROVIDE FIELD APPLIED ENERGY GUARD
- COATING ON UNIT CASING. 11. REFRIGERANT PIPE SIZE SHOWN FOR REFERENCE ONLY. VERIFY
- REFRIGERANT PIPE SIZE REQUIREMENTS WITH MANUFACTURER. 12. WHEN FINAL LENGTH OF REFRIGERANT PIPE IS DETERMINED ON SITE
- COORDINATE WITH MANUFACTURER AND PROVIDE DOUBLE SUCTION RISER WHERE REQUIRED WITH RECOMMENDED PIPE SIZES.
- 13. ACCU-2 AND ACCU-5 HAVE A 2-STAGE COMPRESSOR.

LIQUID LINE SIZE SUCTION LINE SIZE EER @ ARI

11/8"

11/8"

11/8"

11/8"

13/8"

11/8"

11/8"

13/8"

10.9

12.9

13.4

12.9

13.6

DESIGNATION	DESCRIPTION AND REFERENCE SPECIFICATION
KH-1	1. KITCHEN EXHAUST HOOD - ACCUREX XBEW-126-S 126"X48"X24 HIGH 18 GAUGE TYPE 304 STAINLESS STEEL CANOPY HOOD W HANGER BRACKETS AT CORNERS AND EXHAUST COLLAR.
	EXTERIOR JOINTS AND SEAMS SHALL BE LIQUID TIGHT, GROU SMOOTH AND POLISHED

2. PROVIDE AMEREX RP MODEL FSSK FIRE SUPPRESSION SYSTEM (WET CHEMICAL). PROVIDE 304 STAINLESS STEEL PLENUM, 6" WIDE BY LENGTH OF HOOD. MOUNT FLUSH WITH TOP OF HOOD. EXTEND DOWN TO

WEIGHT

1300

430

430

MANUFACTURER

& MODEL NO.

CARRIER

38APD027

CARRIER

38AUZ008

CARRIER

38AUD012

CARRIER

38AUD016

CARRIER

38AUZ008

CARRIER

38AUD025

- WITHIN 32" OF FINISHED FLOOR. 4. PROVIDE FACTORY MOUNTED SUPPLY AND EXHAUST COLLARS. 5. PROVIDE DAMPER AT EXHAUST AIR INTAKE, ACCESSIBLE FROM
- 6. PROVIDE FAN CONTROL CENTER. 7. PROVIDE HOOD ENCLOSURE PANEL, 17" HIGH.
- 8. PROVIDE BACK SPLASH, WIDTH OF HOOD, 32" HIGH. 9. MOUNT FAN CONTROL PANEL, TANK, AND FIRE PROTECTION PANEL
- WITHIN CABINET ON RIGHT END OF HOOD. 10. UL-710 LISTED WITHOUT EXHAUST FIRE DAMPER - UL #R25625. 11. GREASE FILTER AND LIGHTS.

MOUNT BOTTOM OF HOOD 6'-6" ABOVE FINISHED FLOOR.


FACE OF HOOD.

2 04-28-16: ADDENDUM 2

& Associates ARCHITECTS AND **INTERIOR DESIGNERS**

WEIGHT

Final Plans for Bidding and Construction

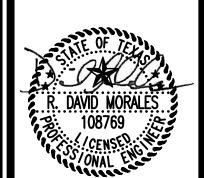

TRIDDE: CALLIN & A\$\$OCIATES INC

Corpus Christi, TX 78405-3615

DATE ISSUED:

April 28, 2016

PROJECT NUMBER:

716-0114B

PLAN NORTH SHEET NAME

SCHEDULES

SHEET NUMBER